



Lower Thames Crossing

2.6 Works Plans Volume B Composite (sheets 1 to 20) (Tracked changes version)

APFP Regulation 5(2)(j)

Infrastructure Planning (Applications:
Prescribed Forms and Procedure)
Regulations 2009

Volume 2

DATE: December 2022

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Version	Date	Submitted at
1.0	31 October 2022	DCO Application
2.0	19 December 2022	Response to advice provided under section 51 of the Planning Act 2008 by the Planning Inspectorate

Contents

List of contents

	Page number
<u>1</u> Introduction	1
<u>2</u> Schedule of Plans included in this application document	6
<u>1</u> Introduction.....	1
<u>2</u> Schedule of Plans included in this application document.....	5

1 Introduction

- 1.1.1 This document is submitted to the Planning Inspectorate on behalf of the Secretary of State in relation to an application made by National Highways (the Applicant) under section 37 of the Planning Act 2008.
- 1.1.2 The Application is for the grant of development consent for the A122 Lower Thames Crossing. Should development consent be granted, the draft A122 (Lower Thames Crossing) Development Consent Order (Application Document 3.1) (the draft Order") will be made by the Secretary of State for Transport (subject to any modifications considered appropriate).
- 1.1.3 This document comprises part of the suite of application documentation and is included in the application to comply with Regulations 5(2)(j) and 5(4) of the Infrastructure Planning (Applications: Prescribed Forms and Procedure) Regulations 2009, which require:
- 5(2)(j) '*a works plan showing, in relation to existing features:*
- (i) *the proposed location or (for a linear scheme) the proposed route and alignment of the development and works; and*
- (ii) *the limits within which the development and works may be carried out and any limits of deviation provided for in the draft order.*
- 5(4) *Where a plan comprises three or more separate sheets a key plan must be provided showing the relationship between the different sheets.'*
- 1.1.4 The purpose of the Works Plans is to illustrate the location and extent of the works for which development consent is sought as described in Schedule 1 of the draft Order (Application Document 3.1). The Applicant has sought to describe the works in Schedule 1 applying, whenever necessary, separate sub-work numbers to provide clarity.
- 1.1.5 In order to assist the interpretation of the Works Plans, the Applicant has prepared Composite sheets, which show all of the works for that sheet, and Utilities sheets, which show only the utility works from the Composite sheet.
- 1.1.6 It should be noted that, for consistency, the Applicant has prepared the Utilities sheets for the entire set.
- 1.1.7 As the Works Plans have been informed by and are part of the application documentation, they should be read alongside the other application documents. In particular, the Works Plans should be read alongside the following:
- Schedule 1 of the draft Order (Application Document 3.1)
 - Land Plans (Application Document 2.2)
 - Rights of Way and Access Plans (Application Document 2.7)
 - Engineering Drawings and Sections Plans (Application Document 2.9)
 - Structures Plans (Application Document 2.13)
 - Temporary Works Plans (Application Document 2.17)

- 1.1.8 Each sheet shows the relevant works numbers applicable within the area shown. Reference should be made to the next relevant sheet for details of works numbers beyond the cut lines. Other information on the Works Plans is shown beyond the cut lines for completeness and context.
- 1.1.9 The Works Plans show the Order Limits and the relevant local authority boundaries for clarity. In this plan set, ‘the Order Limits’ mean the limits of lands to be acquired or used, permanently or temporarily, within which the authorised development may be carried out (see article 2 of the draft Order (Application Document 3.1)).
- 1.1.10 The Works Plans show the centreline for each length of the proposed highway work or linear utility diversion, as well as the boundary for other non-linear works. The proposed highway works centreline is shown in a black dashed line and comprises the road works including streets, public rights of way and private means of access.
- 1.1.11 The proposed diversion or modification of overhead lines is shown in a purple solid line and the temporary diversion alignment is shown in a purple dashed line. The existing overhead lines to be removed as part of the works is shown in a grey dashed line. The proposed underground diversion alignment for gas is shown in an orange solid line and the proposed gas alignment to be removed is shown in orange dashed line. The proposed underground diversion alignment for multi-utilities is shown in blue solid line and the above ground multi-utility compounds are shown in a black box identified as ‘substation SS’. The proposed temporary underground diversion alignment for multi-utilities is shown in light blue solid line.

1.1.12 Start and end points for utilities works are not shown as the centreline and the limits of deviation represent the areas in which the works can be carried out, covering disparate elements of the works which are connected but which do not have the same start and end point. However, for gas utilities works, the alignment line is supported by solid orange squares (at each end) representing the tie-ins into the existing network, where applicable. Where there is no tie-in to the existing gas network no solid orange square is shown. For the overhead lines works, the alignment line includes (along its extent) purple border squares for new permanent pylons, purple dashed border squares for new temporary pylons, grey dashed border squares for existing pylons to be removed and green border squares for existing pylons to be retained. Additional power apparatus (such as poles) are not shown.

1.1.121.1.13 The major proposed structures are highlighted with a black solid box and include structures along the Project mainline and the ground protection tunnel. All these structures have been assigned their own work number, described in Schedule 1 of the draft Order (Application Document 3.1).

1.1.131.1.14 The Works Plans show the areas proposed in the environmental design as new areas to provide mitigation or compensation for the impacts of the Project as black arrow shaded areas. The areas necessary for floodplain compensation are shown as a blue dotted shaded area.

1.1.141.1.15 The Works Plans indicate the location of temporary construction compounds and working sites, listed as numbered works in Schedule 1. A separate set of Temporary Works Plans (Application Document 2.17) has been

prepared to show the location and extent of temporary works, including temporary roads for construction access.

1.1.151.1.16 The design is shown in the background on the Works Plans for illustrative purposes and specifically to provide context and aid understanding of the works. As indicated in the legend, the proposed structures are shown as two solid grey lines; this includes the proposed bridges, viaducts, overbridges, underbridges and retaining walls. It should be noted that proposed bridges, viaducts, overbridges and underbridges are described as a sub-work of a highways linear work in Schedule 1 of the draft Order (Application Document 3.1). For other elements of the works that cannot be separately distinguished from a work or broken down, such as retaining walls, highway drainage ditches and swales, embankments and cuttings earthworks, the Applicant has included these in the list of ancillary works as described in Schedule 1 of the draft Order (Application Document 3.1).

1.1.161.1.17 The proposed drainage culverts are represented in a specific way, as shown in the legend, in an approach consistent with the General Arrangement Plans (Application Document 2.5).

1.1.171.1.18 The commencement and termination of the proposed highways linear works are graphically represented on the plan by different black markers in the shape of bowties (one solid, one hollow). The Applicant has made every effort to represent the bowtie entirely within the Order Limits boundary wherever possible but due to the size of this graphic, this is sometimes unachievable. It is important to note that the start and end points of the works are all within the Order Limits and are defined by the reference points listed in Schedule 1 of the draft Order (Application Document 3.1) and shown in Rights of Way and Access Plans (Application Document 2.7).

1.1.181.1.19 Article 6 of the draft Order (Application Document 3.1) provides for a lateral deviation from the lines or situations shown on the Works Plans to the extent of the defined limits of deviation. This is to provide the Applicant with a limited and proportionate degree of flexibility to allow for detailed design development. The vertical limits of deviation are described in Article 6 of the draft Order (Application Document 3.1).

1.1.191.1.20 The highway works lateral limits of deviation are shown as areas of shaded green on the Composite sheets and the limits of deviation for utility works are indicated by striped areas on the Composite and Utilities sheets as: purple for overhead electricity lines works, orange for gas works, blue for underground multi-utility works and light blue for temporary overhead and multi-utility works. Where relevant, the lateral limits of deviation shown in the Works Plans have been determined considering a range of factors, including earthworks, structures and drainage features. The lateral limits of deviation for tunnels works, such as the tunnel portal structures (south and north), the bored tunnels and the tunnel service buildings are show as part of the highways lateral limits of deviation and also shown in detail in the Tunnel Limits of Deviation Plans (Application Document 2.15).

1.1.201.1.21 Further information about the limits of deviation is provided in the Introduction to the Application (Application Document 1.3). The information shown on the plans is for illustrative purposes only to show the proposed design of the Project and would be subject to detailed design. Detailed design would

be in accordance with the extent of the defined limits of deviation provided in the draft Order and any approval required under the requirements set out in Schedule 2 of the draft Order (Application Document 3.1).

1.1.211.1.22 It should be recognised that there are some instances where the extent of a work shown in the Works Plans and described in Schedule 1 of the draft Order (Application Document 3.1) may differ from the extents provided elsewhere in the draft Order, namely in Schedules 3 and 4 (Application Document 3.1). This is because, in some cases, new public rights of way may be created by a combination of works or the creation of a new public rights of way may be divided into several works. The corresponding commencement and termination points of all the works shown in the Works Plans have a corresponding reference point in the Rights of Way and Access Plans (Application Document 2.7).

1.1.221.1.23 To ensure sufficient detail and clarity of information, the Works Plans (sheets 1 to 49) have been prepared at a scale of 1:2500. The key plan uses a smaller scale than that prescribed in Regulation 5(3) of the 2009 Regulations so that the Project can be represented in a single sheet plan.

1.1.231.1.24 The Applicant has adopted the same approach for the Works Plans as has been used for the following:

- a. Land Plans (Application Document 2.2)
- b. Crown Land Plans (Application Document 2.3)
- c. Special Category Land Plans (Application Document 2.4)
- d. General Arrangement Plans (Application Document 2.5)
- e. Rights of Way and Access Plans (Application Document 2.7)
- f. Streets Subject to Temporary Restrictions of Use Plans (Application Document 2.8)
- g. Traffic Regulation Measures Plans (Application Document 2.10)
- h. Drainage Plans (Application Document 2.16)
- i. Temporary Works Plans (Application Document 2.17)
- j. Hedgerows and Tree Preservation Order Plans (Application Document 2.18)

1.1.241.1.25 The information contained on each sheet of the Works Plans corresponds with the information shown on each sheet of the aforementioned sets. This is intended to help interested parties understand the inter-relationship between the different sets of plans and to help illustrate the design of the Project more clearly.

1.1.251.1.26 It is important to note that there are locations within the DCO boundary where no works are shown on the Works Plans. A number of reasons could

account for this, for example, the land may be required temporarily to provide sufficient working space during construction.

1.1.261.1.27 This plan set uses a consistent key applicable to the plan set as a whole, rather than being tailored to each individual sheet. This means that there may be some items shown in the key that are not on a given sheet.

1.1.271.1.28 To ensure that the file size of this document does not exceed the 50MB limit prescribed by the Planning Inspectorate, the set has been split into six volumes: three separate volumes (volume A contains the key plan, volume B contains the initial sheets 1 to 20 and volume C contains sheets 21 to 49 for the composite plans) and three further separate volumes (volumes A, B and C) for the utilities works.

2 Schedule of Plans included in this application document

Document Title	Document Number	Revision
WORKS PLANS REGULATION 5(2)(j) KEY PLAN – COMPOSITE	TR010032/APP/2.6	P01
WORKS PLANS REGULATION 5(2)(j) SHEET 1 – COMPOSITE	TR010032/APP/2.6	P01
WORKS PLANS REGULATION 5(2)(j) SHEET 2 – COMPOSITE	TR010032/APP/2.6	P01
WORKS PLANS REGULATION 5(2)(j) SHEET 3 – COMPOSITE	TR010032/APP/2.6	P01
WORKS PLANS REGULATION 5(2)(j) SHEET 4 – COMPOSITE	TR010032/APP/2.6	P0 <u>24</u>
WORKS PLANS REGULATION 5(2)(j) SHEET 5 – COMPOSITE	TR010032/APP/2.6	P01
WORKS PLANS REGULATION 5(2)(j) SHEET 6 – COMPOSITE	TR010032/APP/2.6	P0 <u>24</u>
WORKS PLANS REGULATION 5(2)(j) SHEET 7 – COMPOSITE	TR010032/APP/2.6	P01
WORKS PLANS REGULATION 5(2)(j) SHEET 8 – COMPOSITE	TR010032/APP/2.6	P01
WORKS PLANS REGULATION 5(2)(j) SHEET 9 – COMPOSITE	TR010032/APP/2.6	P01
WORKS PLANS REGULATION 5(2)(j) SHEET 10 – COMPOSITE	TR010032/APP/2.6	P01

Document Title	Document Number	Revision
WORKS PLANS REGULATION 5(2)(j) SHEET 11 – COMPOSITE	TR010032/APP/2.6	P0 <u>24</u>
WORKS PLANS REGULATION 5(2)(j) SHEET 12 – COMPOSITE	TR010032/APP/2.6	P0 <u>24</u>
WORKS PLANS REGULATION 5(2)(j) SHEET 13 – COMPOSITE	TR010032/APP/2.6	P01
WORKS PLANS REGULATION 5(2)(j) SHEET 14 – COMPOSITE	TR010032/APP/2.6	P0 <u>24</u>
WORKS PLANS REGULATION 5(2)(j) SHEET 15 – COMPOSITE	TR010032/APP/2.6	P0 <u>24</u>
WORKS PLANS REGULATION 5(2)(j) SHEET 16 – COMPOSITE	TR010032/APP/2.6	P01
WORKS PLANS REGULATION 5(2)(j) SHEET 17 – COMPOSITE	TR010032/APP/2.6	P01
WORKS PLANS REGULATION 5(2)(j) SHEET 18 – COMPOSITE	TR010032/APP/2.6	P01
WORKS PLANS REGULATION 5(2)(j) SHEET 19 – COMPOSITE	TR010032/APP/2.6	P01
WORKS PLANS REGULATION 5(2)(j) SHEET 20 – COMPOSITE	TR010032/APP/2.6	P01
WORKS PLANS REGULATION 5(2)(j) SHEET 21 – COMPOSITE	TR010032/APP/2.6	P01
WORKS PLANS REGULATION 5(2)(j) SHEET 22 – COMPOSITE	TR010032/APP/2.6	P01
WORKS PLANS REGULATION 5(2)(j) SHEET 23 – COMPOSITE	TR010032/APP/2.6	P0 <u>24</u>

Document Title	Document Number	Revision
WORKS PLANS REGULATION 5(2)(j) SHEET 24 – COMPOSITE	TR010032/APP/2.6	P0 <u>24</u>
WORKS PLANS REGULATION 5(2)(j) SHEET 25 – COMPOSITE	TR010032/APP/2.6	P01
WORKS PLANS REGULATION 5(2)(j) SHEET 26 – COMPOSITE	TR010032/APP/2.6	P01
WORKS PLANS REGULATION 5(2)(j) SHEET 27 – COMPOSITE	TR010032/APP/2.6	P01
WORKS PLANS REGULATION 5(2)(j) SHEET 28 – COMPOSITE	TR010032/APP/2.6	P0 <u>24</u>
WORKS PLANS REGULATION 5(2)(j) SHEET 29 – COMPOSITE	TR010032/APP/2.6	P0 <u>24</u>
WORKS PLANS REGULATION 5(2)(j) SHEET 30 – COMPOSITE	TR010032/APP/2.6	P01
WORKS PLANS REGULATION 5(2)(j) SHEET 31 – COMPOSITE	TR010032/APP/2.6	P0 <u>24</u>
WORKS PLANS REGULATION 5(2)(j) SHEET 32 – COMPOSITE	TR010032/APP/2.6	P0 <u>24</u>
WORKS PLANS REGULATION 5(2)(j) SHEET 33 – COMPOSITE	TR010032/APP/2.6	P0 <u>24</u>
WORKS PLANS REGULATION 5(2)(j) SHEET 34 – COMPOSITE	TR010032/APP/2.6	P0 <u>24</u>
WORKS PLANS REGULATION 5(2)(j) SHEET 35 – COMPOSITE	TR010032/APP/2.6	P0 <u>24</u>
WORKS PLANS REGULATION 5(2)(j) SHEET 36 – COMPOSITE	TR010032/APP/2.6	P01


Document Title	Document Number	Revision
WORKS PLANS REGULATION 5(2)(j) SHEET 37 – COMPOSITE	TR010032/APP/2.6	P01
WORKS PLANS REGULATION 5(2)(j) SHEET 38 – COMPOSITE	TR010032/APP/2.6	P0 <u>24</u>
WORKS PLANS REGULATION 5(2)(j) SHEET 39 – COMPOSITE	TR010032/APP/2.6	P0 <u>24</u>
WORKS PLANS REGULATION 5(2)(j) SHEET 40 – COMPOSITE	TR010032/APP/2.6	P0 <u>24</u>
WORKS PLANS REGULATION 5(2)(j) SHEET 41 – COMPOSITE	TR010032/APP/2.6	P01
WORKS PLANS REGULATION 5(2)(j) SHEET 42 – COMPOSITE	TR010032/APP/2.6	P01
WORKS PLANS REGULATION 5(2)(j) SHEET 43 – COMPOSITE	TR010032/APP/2.6	P0 <u>24</u>
WORKS PLANS REGULATION 5(2)(j) SHEET 44 – COMPOSITE	TR010032/APP/2.6	P01
WORKS PLANS REGULATION 5(2)(j) SHEET 45 – COMPOSITE	TR010032/APP/2.6	P0 <u>24</u>
WORKS PLANS REGULATION 5(2)(j) SHEET 46 – COMPOSITE	TR010032/APP/2.6	P01
WORKS PLANS REGULATION 5(2)(j) SHEET 47 – COMPOSITE	TR010032/APP/2.6	P0 <u>24</u>
WORKS PLANS REGULATION 5(2)(j) SHEET 48 – COMPOSITE	TR010032/APP/2.6	P01
WORKS PLANS REGULATION 5(2)(j) SHEET 49 – COMPOSITE	TR010032/APP/2.6	P01

Document Title	Document Number	Revision
WORKS PLANS REGULATION 5(2)(j) KEY PLAN – UTILITIES	TR010032/APP/2.6	P01
WORKS PLANS REGULATION 5(2)(j) SHEET 1 – UTILITIES	TR010032/APP/2.6	P01
WORKS PLANS REGULATION 5(2)(j) SHEET 2 – UTILITIES	TR010032/APP/2.6	P01
WORKS PLANS REGULATION 5(2)(j) SHEET 3 – UTILITIES	TR010032/APP/2.6	P01
WORKS PLANS REGULATION 5(2)(j) SHEET 4 – UTILITIES	TR010032/APP/2.6	P0 <u>24</u>
WORKS PLANS REGULATION 5(2)(j) SHEET 5 – UTILITIES	TR010032/APP/2.6	P01
WORKS PLANS REGULATION 5(2)(j) SHEET 6 – UTILITIES	TR010032/APP/2.6	P0 <u>24</u>
WORKS PLANS REGULATION 5(2)(j) SHEET 7 – UTILITIES	TR010032/APP/2.6	P01
WORKS PLANS REGULATION 5(2)(j) SHEET 8 – UTILITIES	TR010032/APP/2.6	P01
WORKS PLANS REGULATION 5(2)(j) SHEET 9 – UTILITIES	TR010032/APP/2.6	P01
WORKS PLANS REGULATION 5(2)(j) SHEET 10 – UTILITIES	TR010032/APP/2.6	P01
WORKS PLANS REGULATION 5(2)(j) SHEET 11 – UTILITIES	TR010032/APP/2.6	P01
WORKS PLANS REGULATION 5(2)(j) SHEET 12 – UTILITIES	TR010032/APP/2.6	P0 <u>24</u>

Document Title	Document Number	Revision
WORKS PLANS REGULATION 5(2)(j) SHEET 13 – UTILITIES	TR010032/APP/2.6	P01
WORKS PLANS REGULATION 5(2)(j) SHEET 14 – UTILITIES	TR010032/APP/2.6	P01
WORKS PLANS REGULATION 5(2)(j) SHEET 15 – UTILITIES	TR010032/APP/2.6	P01
WORKS PLANS REGULATION 5(2)(j) SHEET 16 – UTILITIES	TR010032/APP/2.6	P01
WORKS PLANS REGULATION 5(2)(j) SHEET 17 – UTILITIES	TR010032/APP/2.6	P01
WORKS PLANS REGULATION 5(2)(j) SHEET 18 – UTILITIES	TR010032/APP/2.6	P01
WORKS PLANS REGULATION 5(2)(j) SHEET 19 – UTILITIES	TR010032/APP/2.6	P01
WORKS PLANS REGULATION 5(2)(j) SHEET 20 – UTILITIES	TR010032/APP/2.6	P01
WORKS PLANS REGULATION 5(2)(j) SHEET 21 – UTILITIES	TR010032/APP/2.6	P01
WORKS PLANS REGULATION 5(2)(j) SHEET 22 – UTILITIES	TR010032/APP/2.6	P01
WORKS PLANS REGULATION 5(2)(j) SHEET 23 – UTILITIES	TR010032/APP/2.6	P01
WORKS PLANS REGULATION 5(2)(j) SHEET 24 – UTILITIES	TR010032/APP/2.6	P01
WORKS PLANS REGULATION 5(2)(j) SHEET 25 – UTILITIES	TR010032/APP/2.6	P01

Document Title	Document Number	Revision
WORKS PLANS REGULATION 5(2)(j) SHEET 26 – UTILITIES	TR010032/APP/2.6	P01
WORKS PLANS REGULATION 5(2)(j) SHEET 27 – UTILITIES	TR010032/APP/2.6	P01
WORKS PLANS REGULATION 5(2)(j) SHEET 28 – UTILITIES	TR010032/APP/2.6	P01
WORKS PLANS REGULATION 5(2)(j) SHEET 29 – UTILITIES	TR010032/APP/2.6	P01
WORKS PLANS REGULATION 5(2)(j) SHEET 30 – UTILITIES	TR010032/APP/2.6	P01
WORKS PLANS REGULATION 5(2)(j) SHEET 31 – UTILITIES	TR010032/APP/2.6	P01
WORKS PLANS REGULATION 5(2)(j) SHEET 32 – UTILITIES	TR010032/APP/2.6	P0 <u>24</u>
WORKS PLANS REGULATION 5(2)(j) SHEET 33 – UTILITIES	TR010032/APP/2.6	P01
WORKS PLANS REGULATION 5(2)(j) SHEET 34 – UTILITIES	TR010032/APP/2.6	P01
WORKS PLANS REGULATION 5(2)(j) SHEET 35 – UTILITIES	TR010032/APP/2.6	P01
WORKS PLANS REGULATION 5(2)(j) SHEET 36 – UTILITIES	TR010032/APP/2.6	P01
WORKS PLANS REGULATION 5(2)(j) SHEET 37 – UTILITIES	TR010032/APP/2.6	P01
WORKS PLANS REGULATION 5(2)(j) SHEET 38 – UTILITIES	TR010032/APP/2.6	P0 <u>24</u>

Document Title	Document Number	Revision
WORKS PLANS REGULATION 5(2)(j) SHEET 39 – UTILITIES	TR010032/APP/2.6	P0 <u>24</u>
WORKS PLANS REGULATION 5(2)(j) SHEET 40 – UTILITIES	TR010032/APP/2.6	P0 <u>24</u>
WORKS PLANS REGULATION 5(2)(j) SHEET 41 – UTILITIES	TR010032/APP/2.6	P01
WORKS PLANS REGULATION 5(2)(j) SHEET 42 – UTILITIES	TR010032/APP/2.6	P01
WORKS PLANS REGULATION 5(2)(j) SHEET 43 – UTILITIES	TR010032/APP/2.6	P01
WORKS PLANS REGULATION 5(2)(j) SHEET 44 – UTILITIES	TR010032/APP/2.6	P01
WORKS PLANS REGULATION 5(2)(j) SHEET 45 – UTILITIES	TR010032/APP/2.6	P01
WORKS PLANS REGULATION 5(2)(j) SHEET 46 – UTILITIES	TR010032/APP/2.6	P01
WORKS PLANS REGULATION 5(2)(j) SHEET 47 – UTILITIES	TR010032/APP/2.6	P01
WORKS PLANS REGULATION 5(2)(j) SHEET 48 – UTILITIES	TR010032/APP/2.6	P01
WORKS PLANS REGULATION 5(2)(j) SHEET 49 – UTILITIES	TR010032/APP/2.6	P01

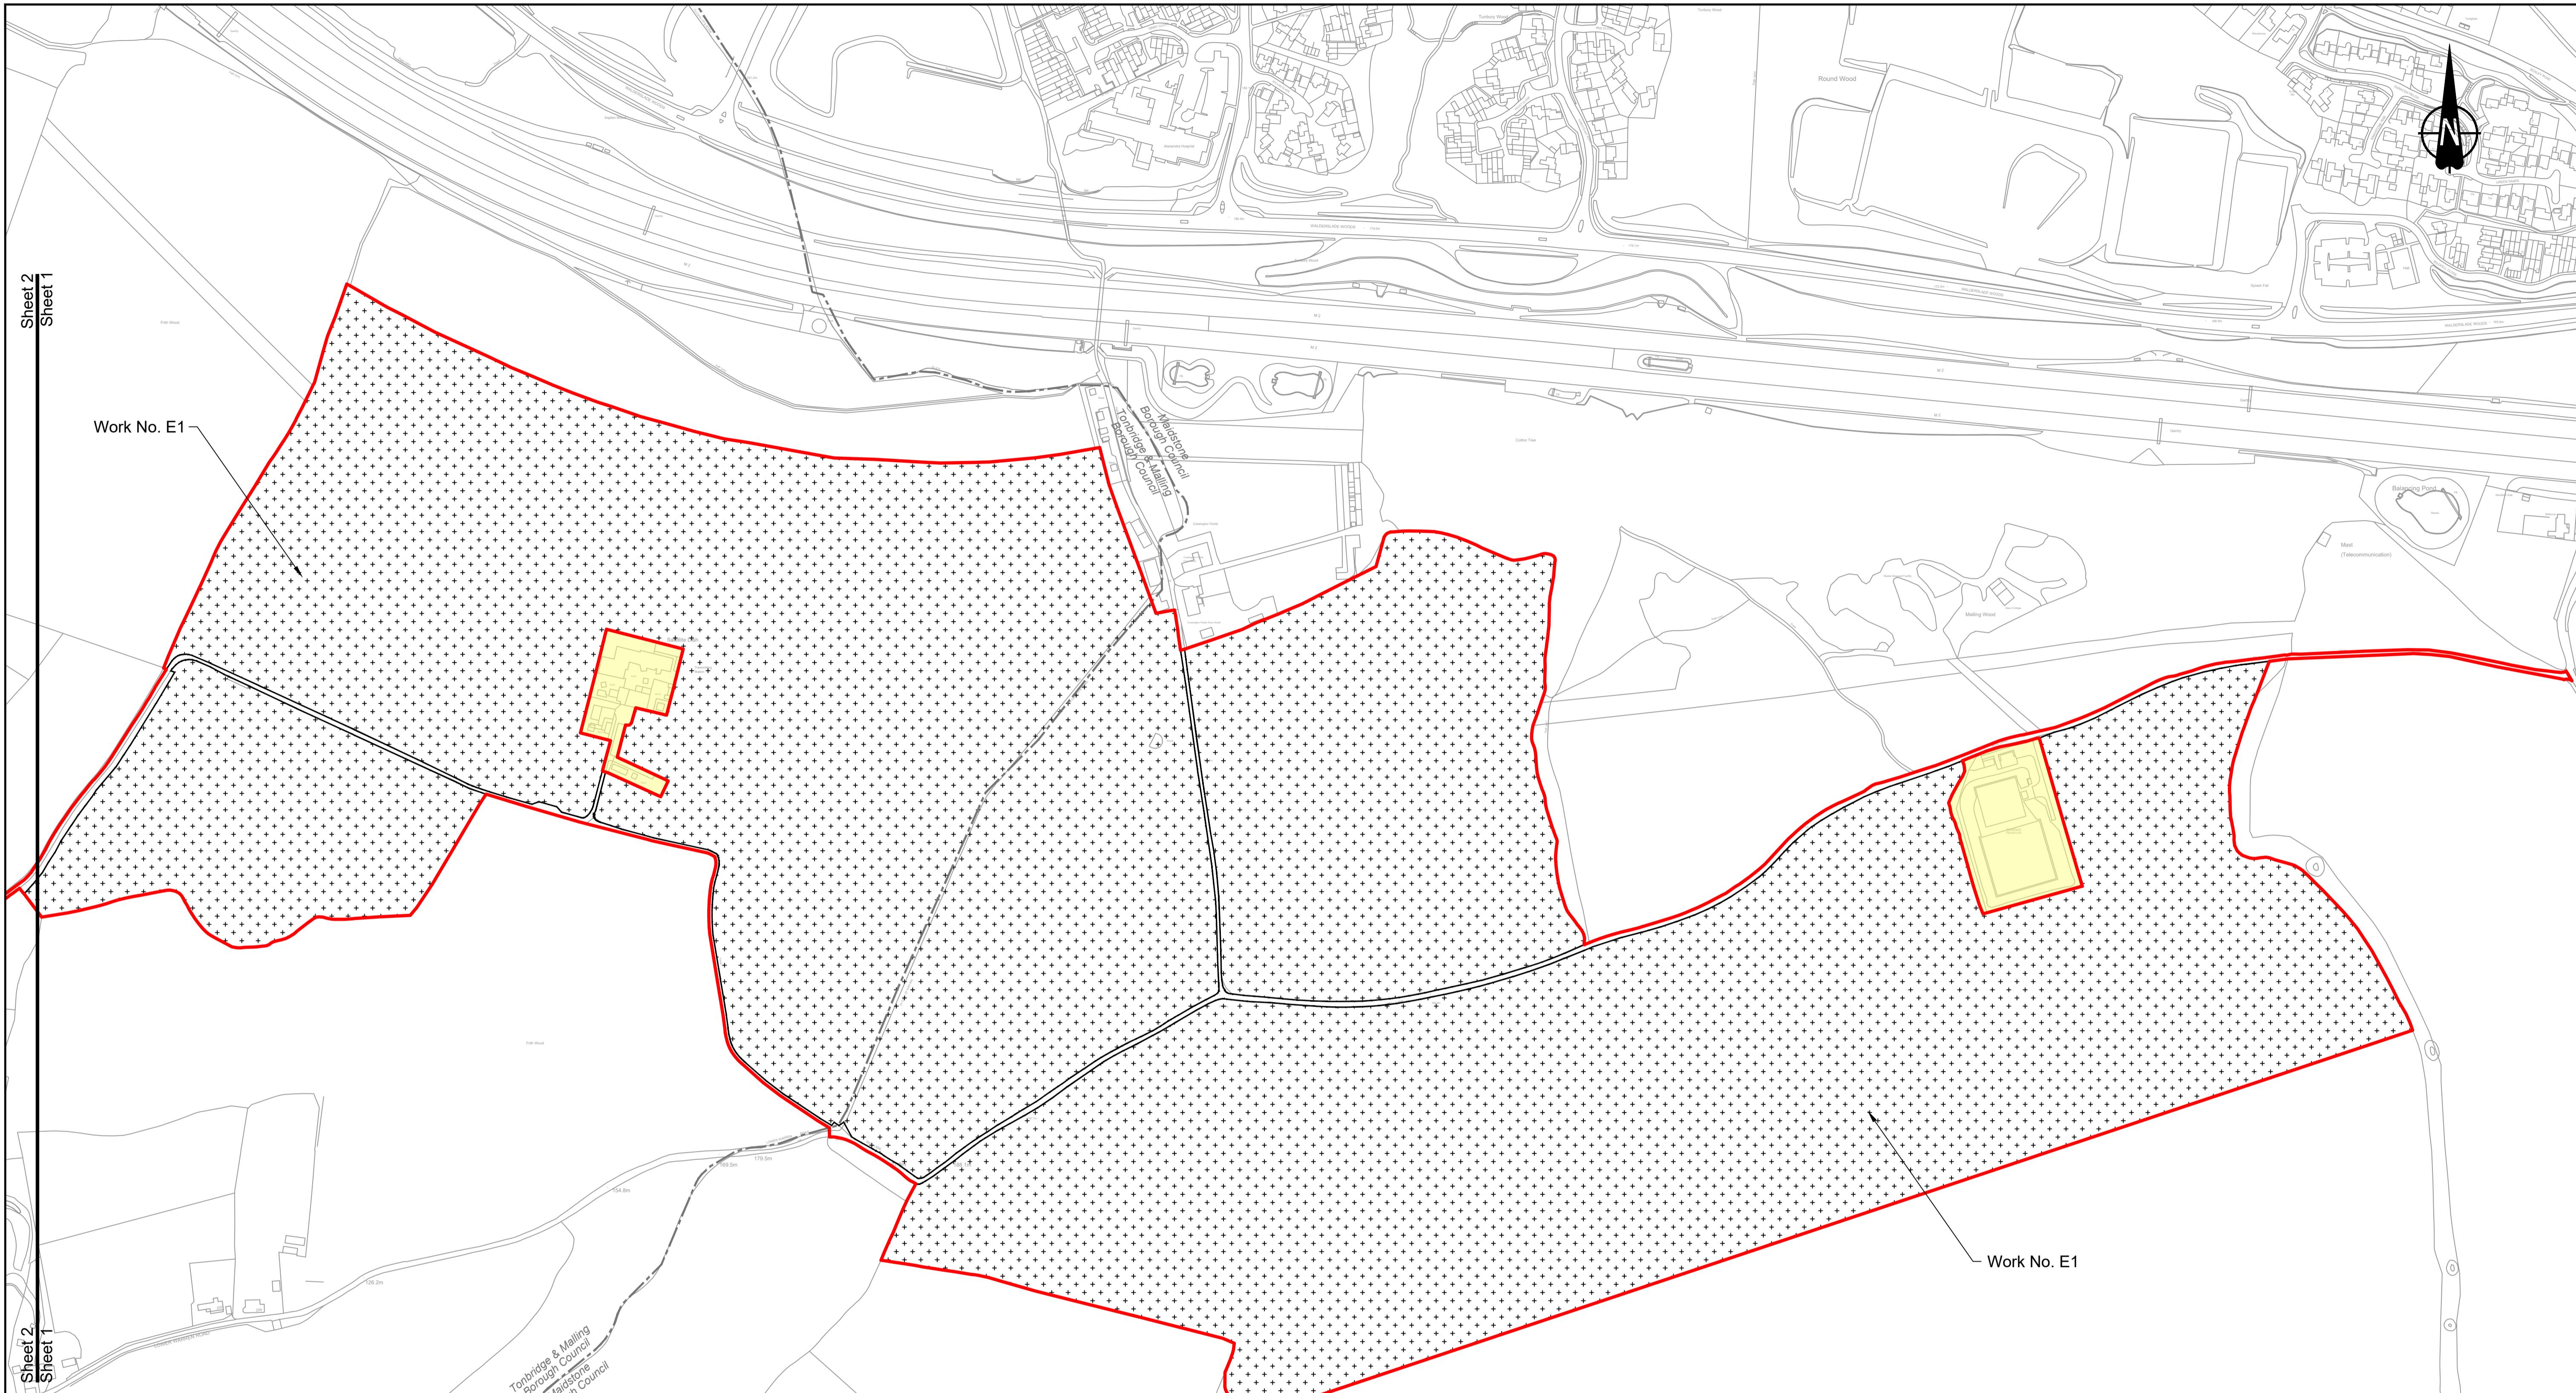

Utility Legend:

- Indicative diverted and modified overhead electricity lines
- Existing overhead electricity lines to be removed
- Indicative temporary overhead electricity lines
- Indicative underground gas diversion
- Maximum extent of existing gas pipeline to be removed
- Indicative underground multi-utility alignment
- Indicative temporary underground multi-utility alignment
- Overhead electricity lines works Limits of Deviation
- Gas works Limits of Deviation
- Underground multi-utility works Limits of Deviation
- Temporary overhead electricity lines and multi-utility works Limits of Deviation
- Substation SS
- Existing pylon to be retained

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P01 S8 19/10/2022 DCO Application MS RO ASB

Rev Status Rev. Date Purpose of revision Drawn Chkd Apprv'd

- NOTES:
- The proposed works shown are illustrative only and will be subject to change as part of detailed design development. Any changes will be limited to being within the constraints included in the Development Consent Order (application document reference TR010032/APP/3.1).
 - These plans should be read in conjunction with Schedule 1 (Authorised Development) of the Development Consent Order (application document reference TR010032/APP/3.1), the Land Plans (application document reference TR010032/APP/2.2) and the Engineering Drawings and Sections (application document reference TR010032/APP/2.9).
 - Proposed works are shown adjacent to the Order Limits to provide greater clarity of the extent of the work but could extend to the Order Limits as well.
 - The definition of streets is included in the Development Consent Order (application document reference TR010032/APP/3.1).

LEGEND:

Order Limits	Flood compensation area	Commencement of linear work	Ecological habitat creation and receptor site for protected species
Linear Work Centreline (including streets)	Culvert	Commencement and termination of linear work	Temporary ecological habitat
Local Authority boundary	Bridge/structure	Termination of linear work	Open space provision, replacement open space or replacement common land
Highway Work (includes structures) Limits of Deviation	Watercourse diversion work centreline	Bat Barn structure	Travellers site
	Infiltration basin, detention basin or retention pond boundary	Construction Area - Utilities Logistic Hub	Water inlet with self-regulating valve
	Major structure	Construction Area - Main Works Compound	

Area excluded from Order Limits

Major structure

Construction Area - Main Works Compound

Utilities Logistic Hub

Construction Area - Main Works Compound

Major structure

Construction Area - Main Works Compound

Utilities Logistic Hub

Construction Area - Main Works Compound

Major structure

Construction Area - Main Works Compound

Utilities Logistic Hub

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Construction Area - Main Works Compound

Utilities Logistic Hub

Construction Area - Main Works Compound

Major structure

Construction Area - Main Works Compound

Utilities Logistic Hub

Construction Area - Main Works Compound

Major structure

Construction Area - Main Works Compound

Utilities Logistic Hub

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Construction Area - Main Works Compound

Major structure

Construction Area - Main Works Compound

Utilities Logistic Hub

Construction Area - Main Works Compound

Major structure

Construction Area - Main Works Compound


Utilities Logistic Hub


Construction Area - Main Works Compound

Major structure

Construction Area - Main Works Compound

Utilities Logistic Hub

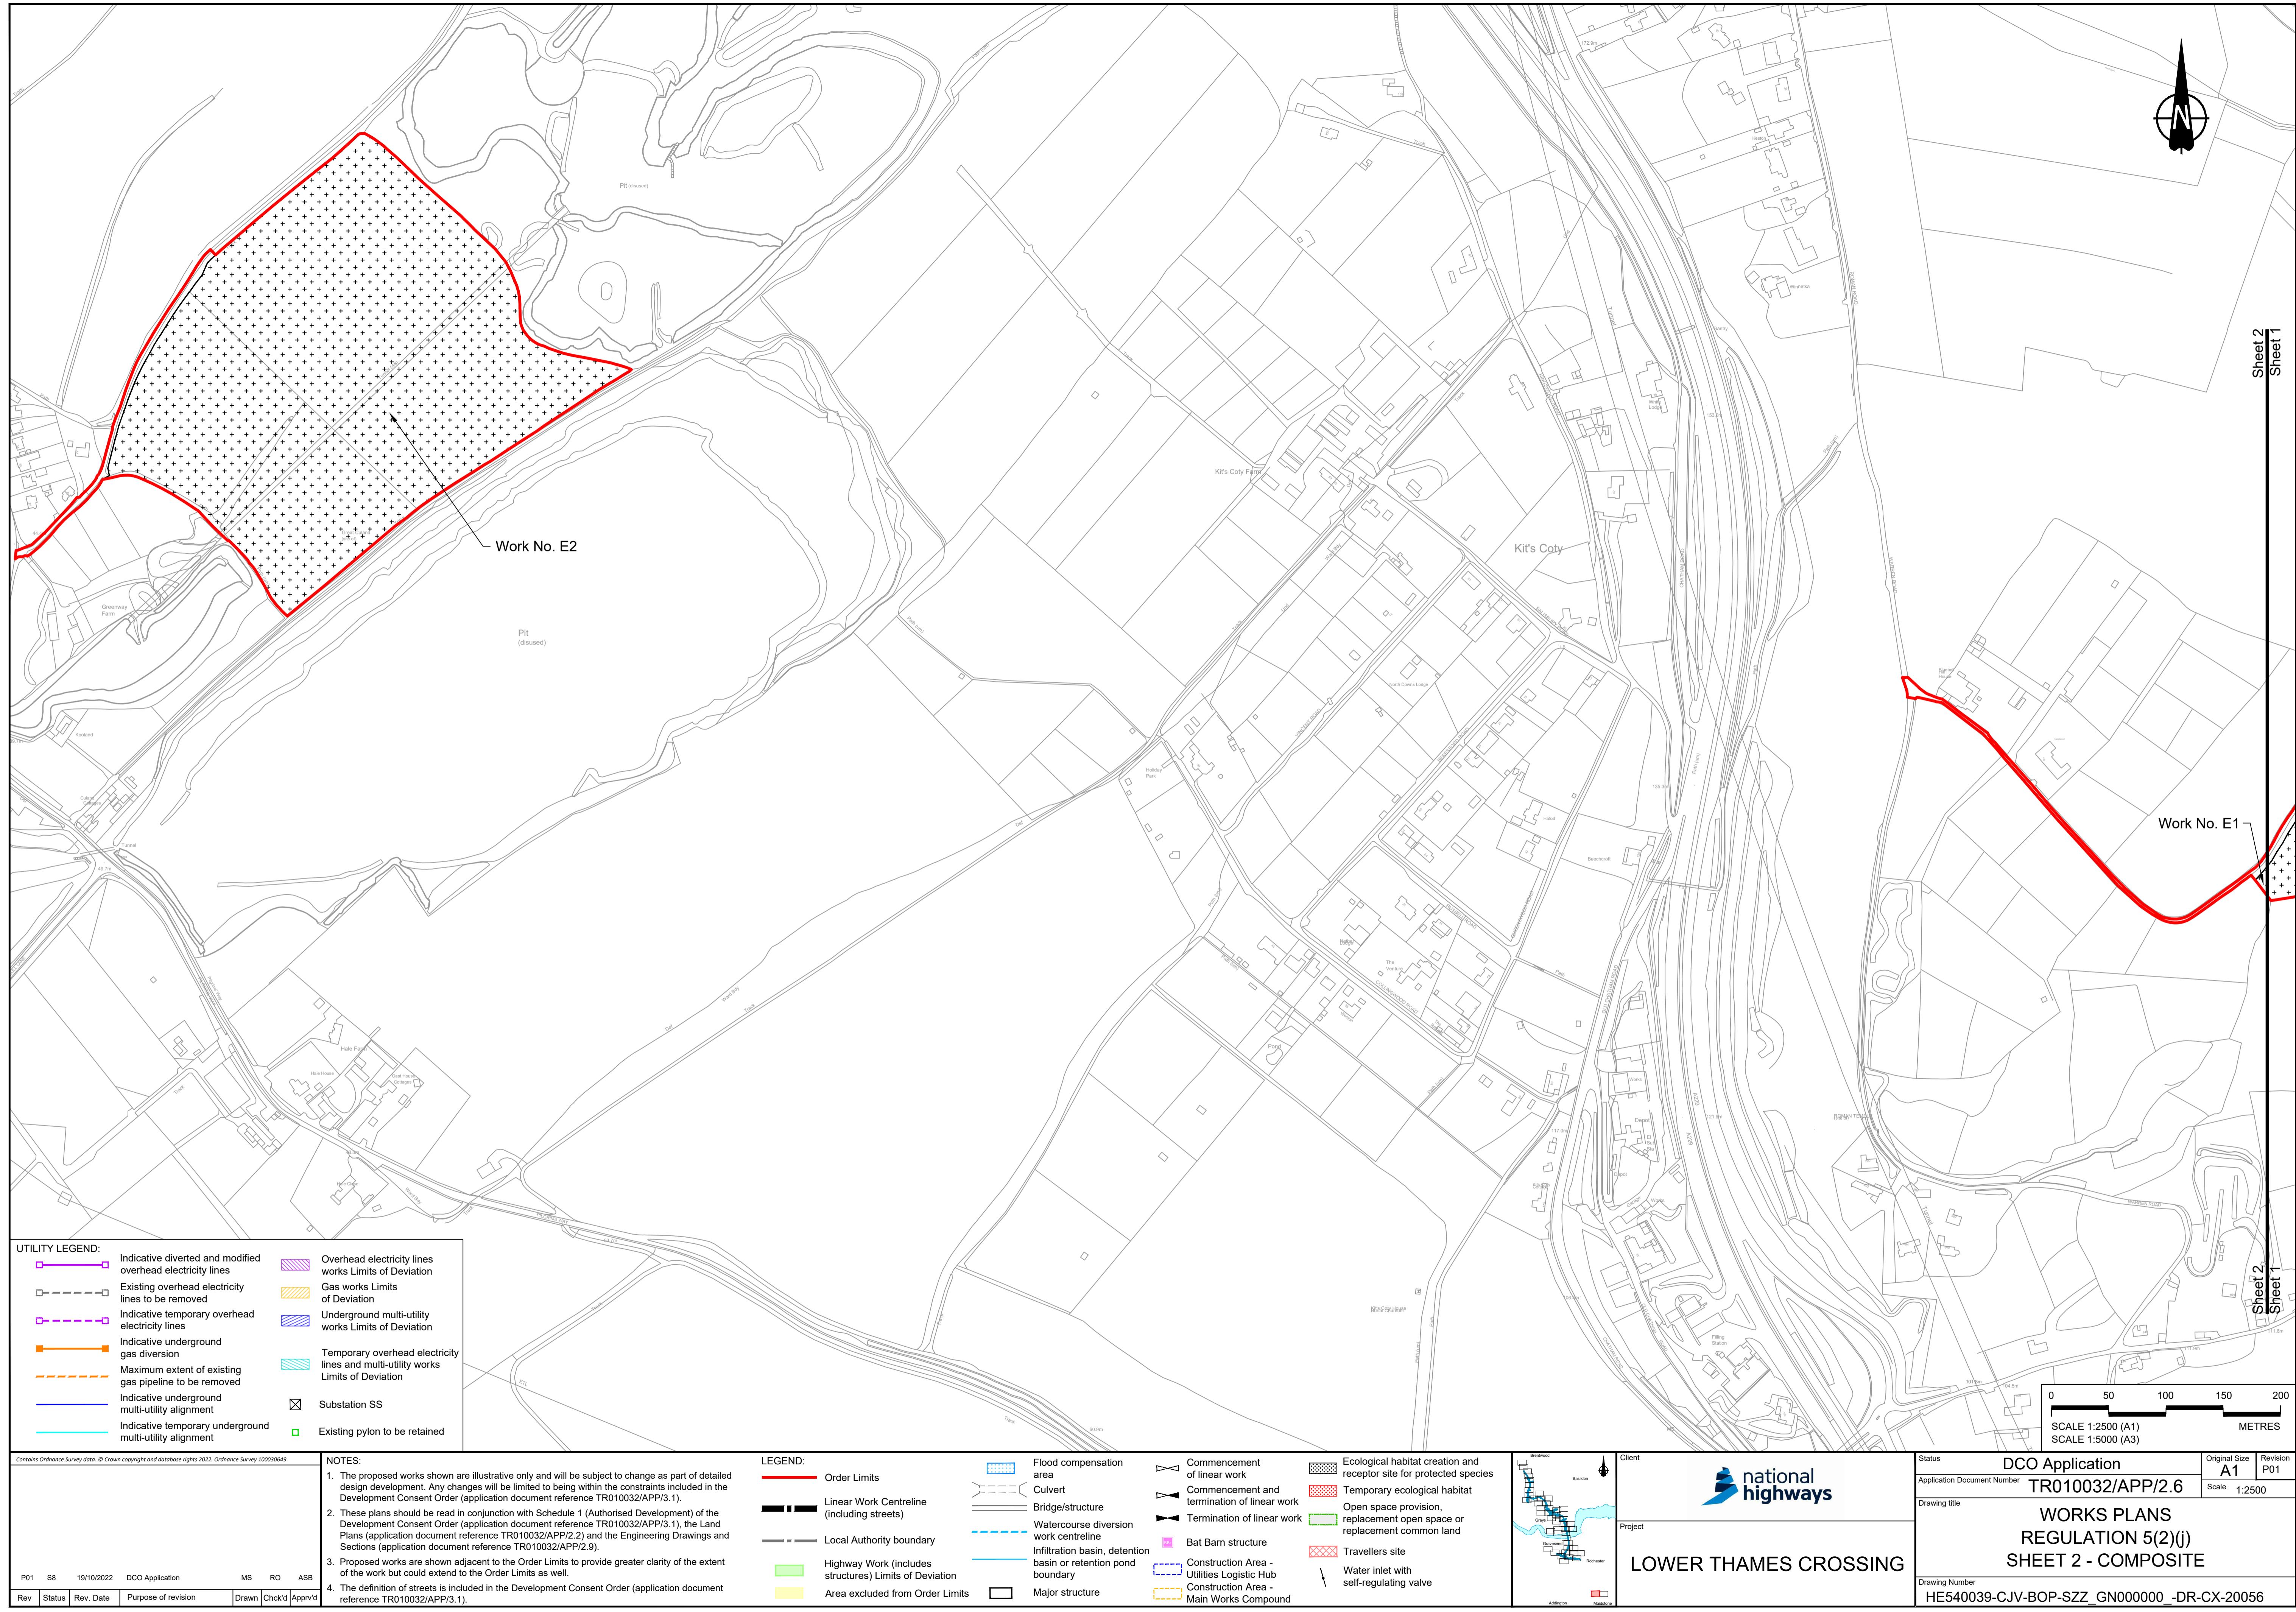

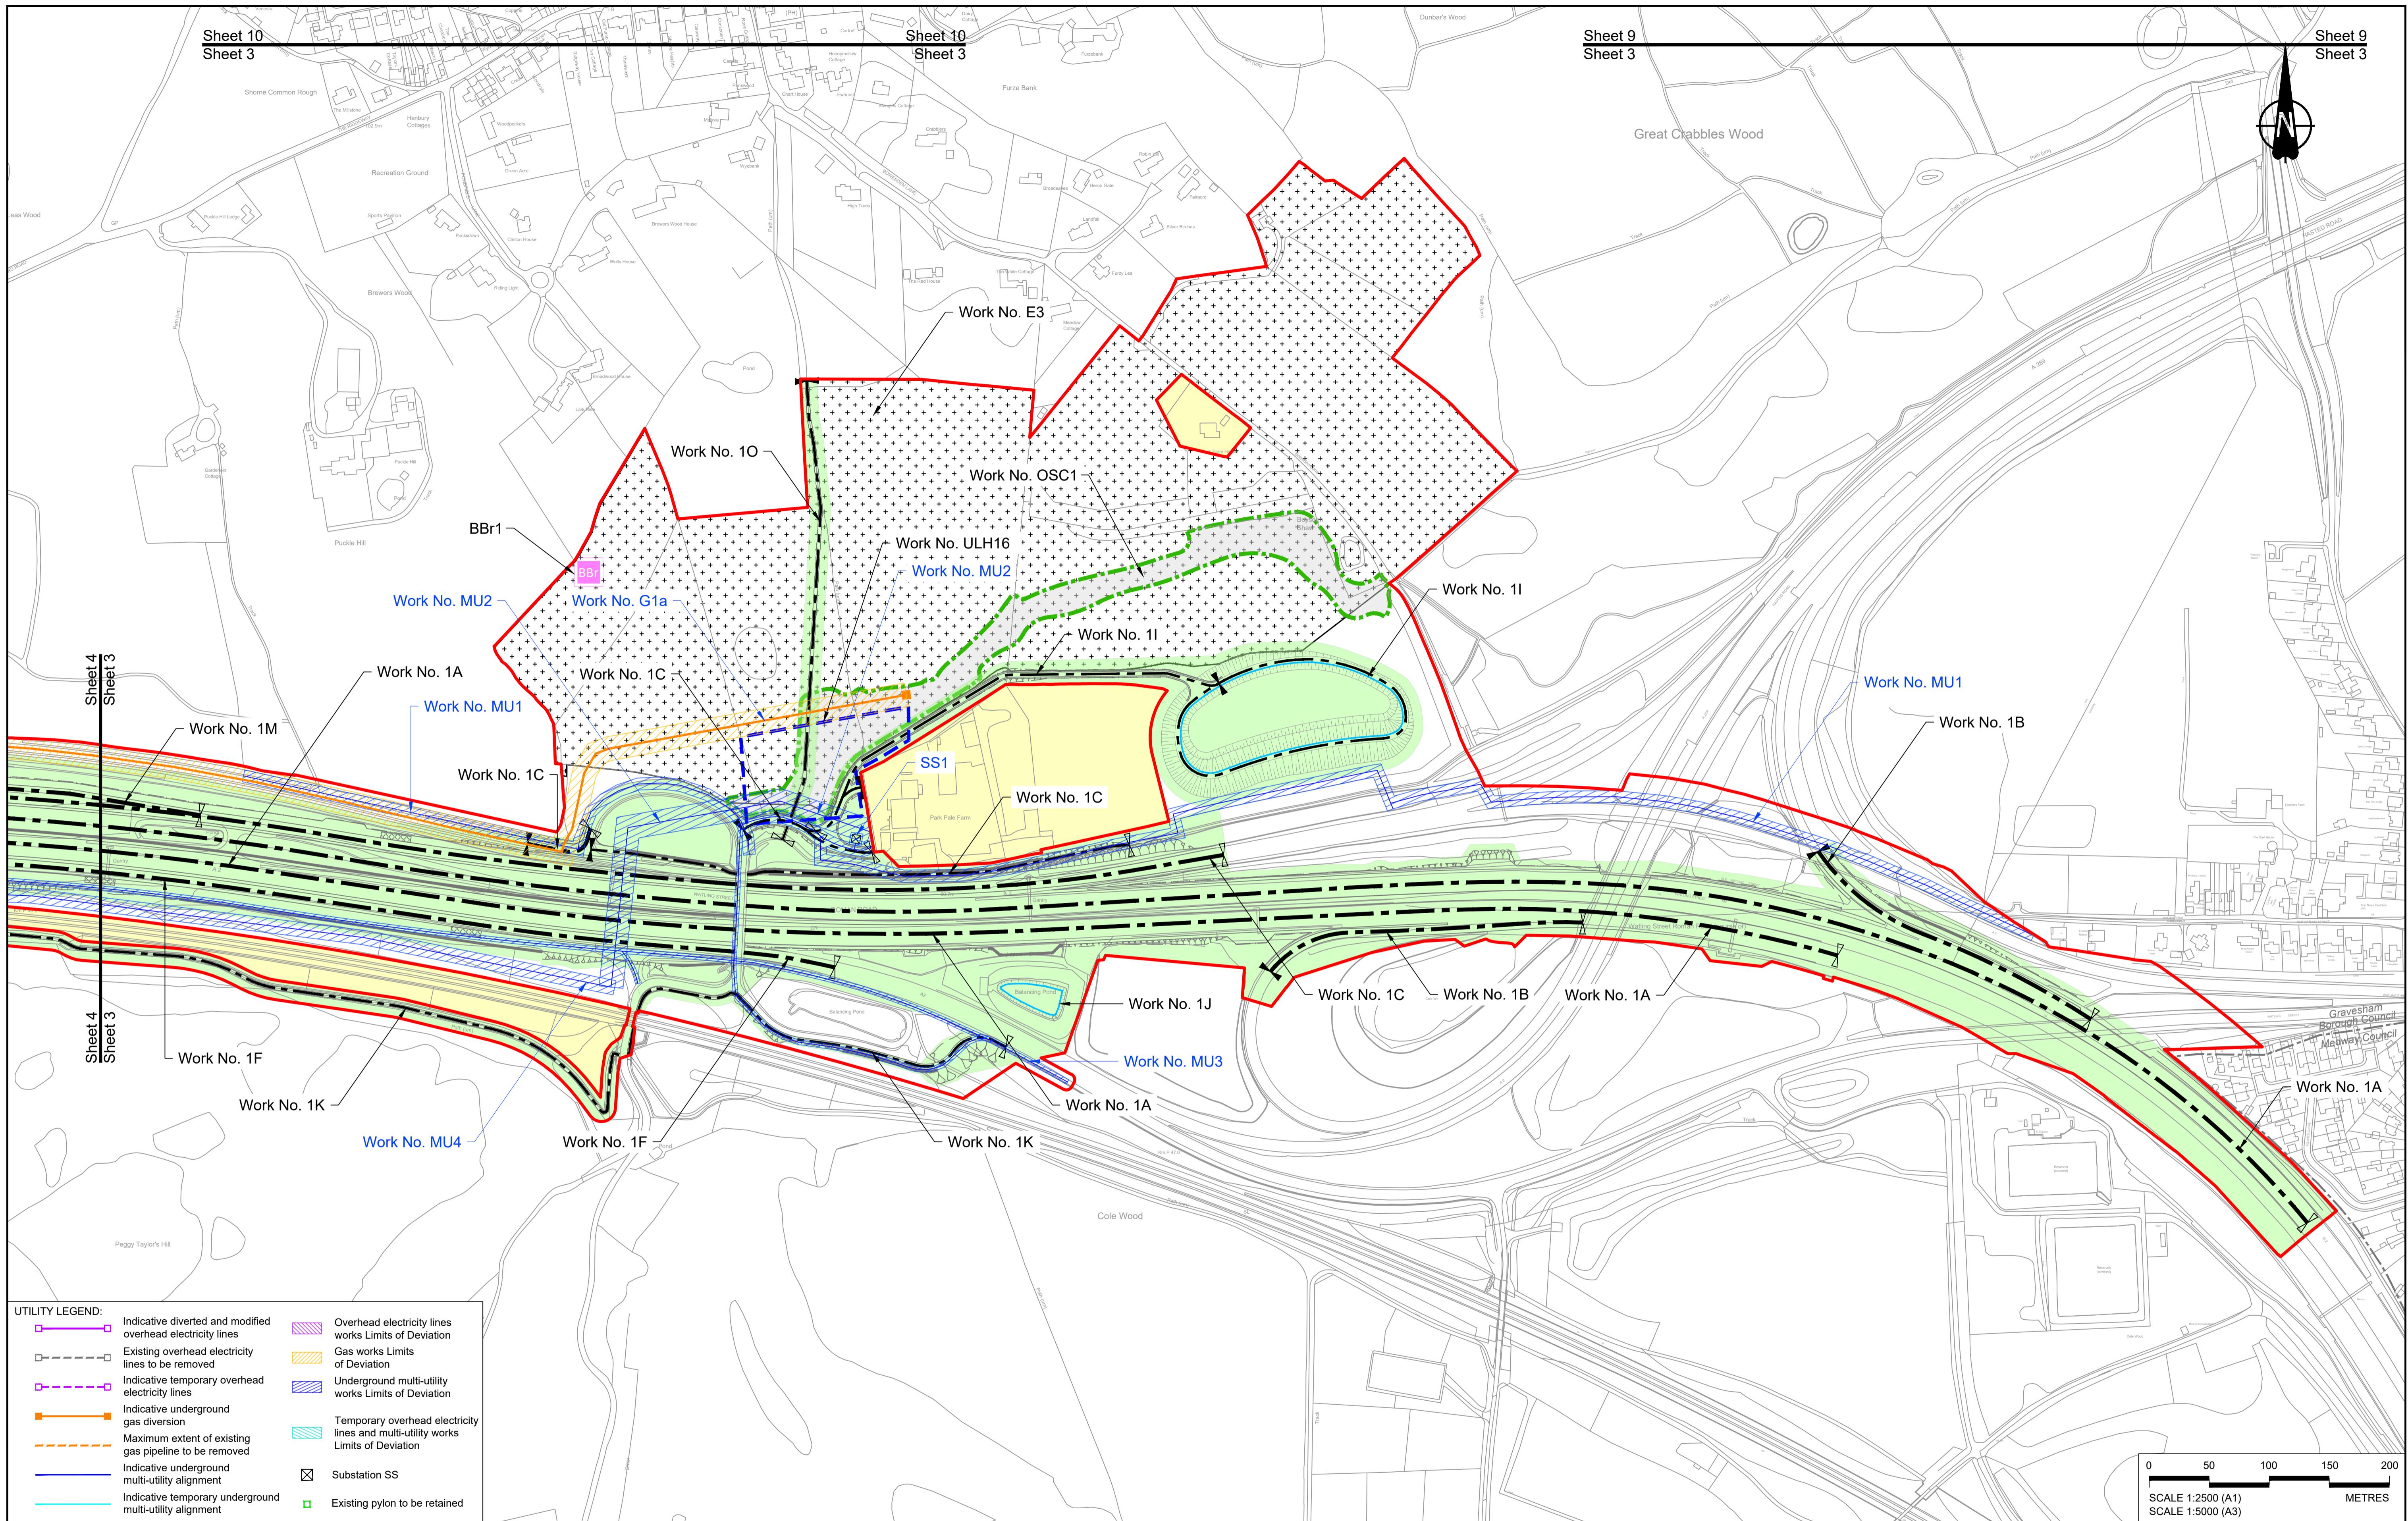

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NOTES:

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- The definition of streets is included in the Development Consent Order (application document reference TR010032/APP/3.1).

LEGEND:


- Order Limits
- Linear Work Centreline (including streets)
- Local Authority boundary
- Highway Work (includes structures) Limits of Deviation
- Area excluded from Order Limits
- Flood compensation area
- Culvert
- Bridge/structure
- Watercourse diversion work centreline
- Infiltration basin, detention basin or retention pond boundary
- Major structure
- Commencement of linear work
- Commencement and termination of linear work
- Termination of linear work
- Bat Barn structure
- Construction Area - Utilities Logistic Hub
- Construction Area - Main Works Compound
- Ecological habitat creation and receptor site for protected species
- Temporary ecological habitat
- Open space provision, replacement open space or replacement common land
- Travellers site
- Water inlet with self-regulating valve

P01 S8 19/10/2022 DCO Application MS RO ASB

Rev Status Rev. Date Purpose of revision Drawn Chkd Apprv'd

Status	DCO Application	Original Size A1	Revision P01
Application Document Number	TR010032/APP/2.6	Scale	1:2500
Drawing title	WORKS PLANS		
	REGULATION 5(2)(j)		
Project	LOWER THAMES CROSSING		
Drawing Number	HE540039-CJV-BOP-SZZ_GN000000_DR-CX-20001		

HE540039-CJV-BOP-SZZ_GN000000_DR-CX-20001.dwg

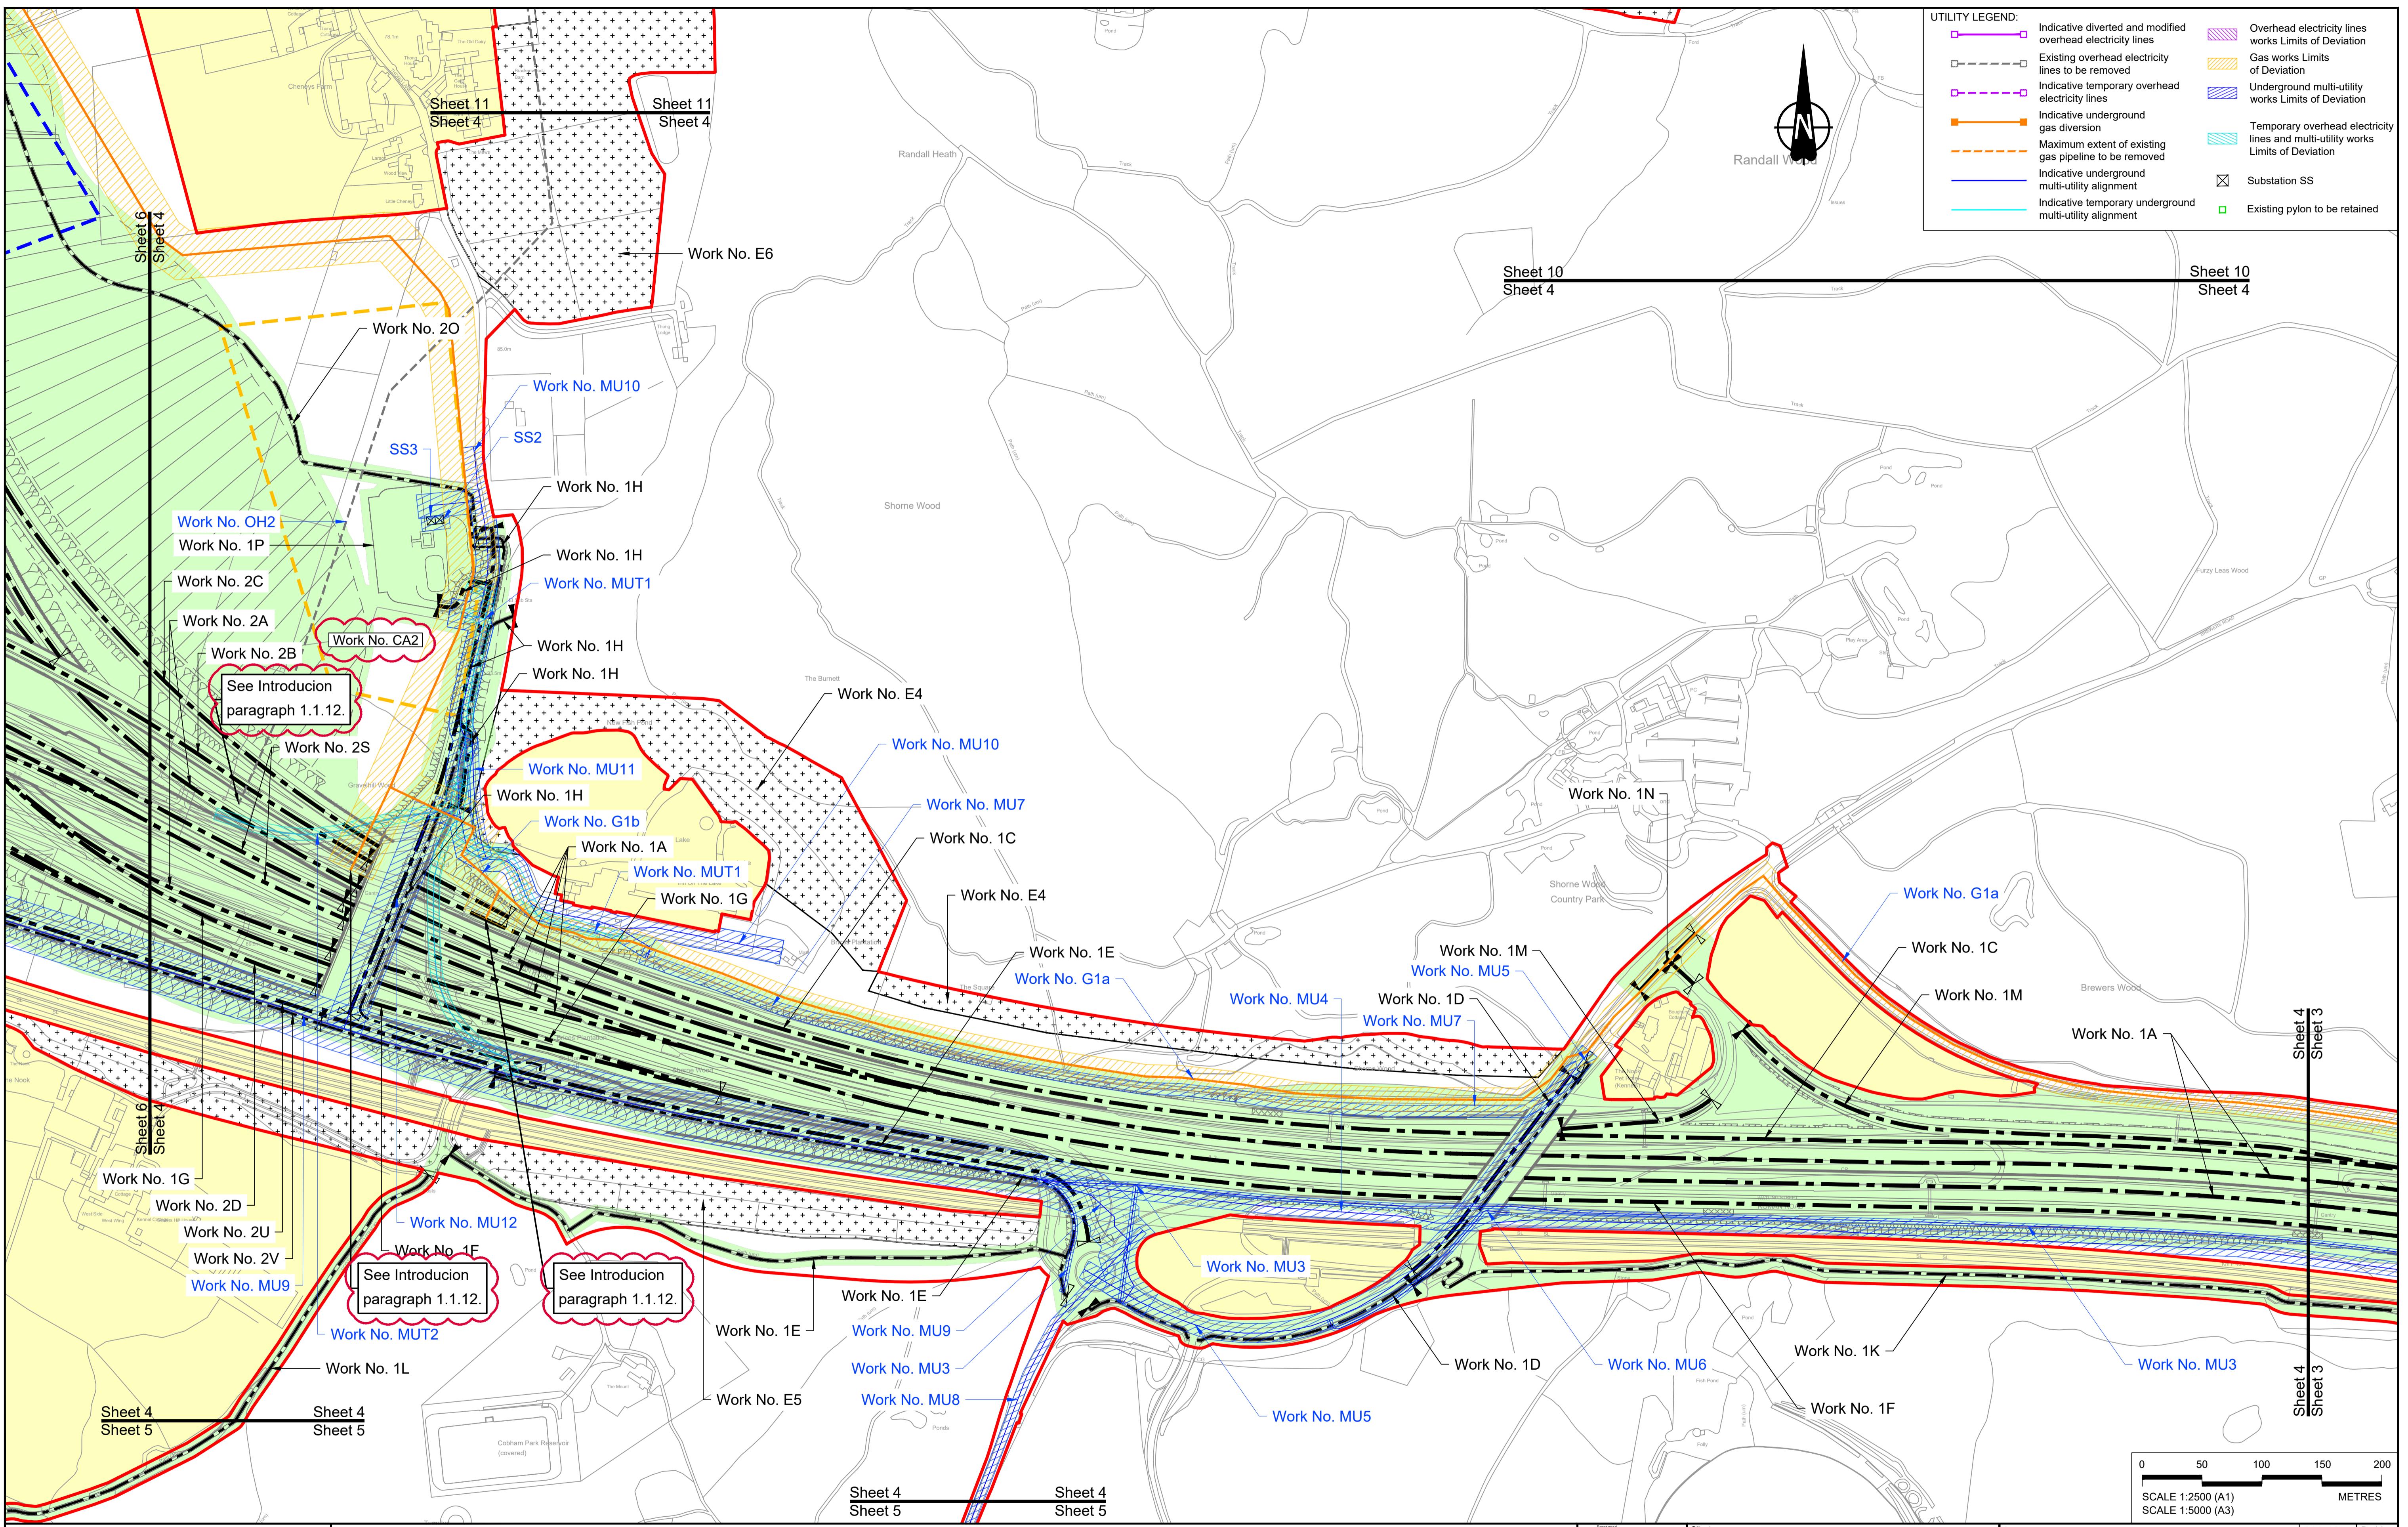




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- NOTES:**

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 4. The definition of streets is included in the Development Consent Order (application document reference TR010032/APP/3.1).

LEGEND:


- Order Limits**: Red line.
- Linear Work Centreline (including streets)**: Black line with a small black square marker.
- Local Authority boundary**: Grey line with a dashed segment.
- Highway Work (includes structures) Limits of Deviations**: Green box.
- Area excluded from Order**: Yellow box.

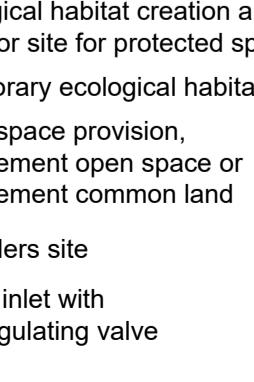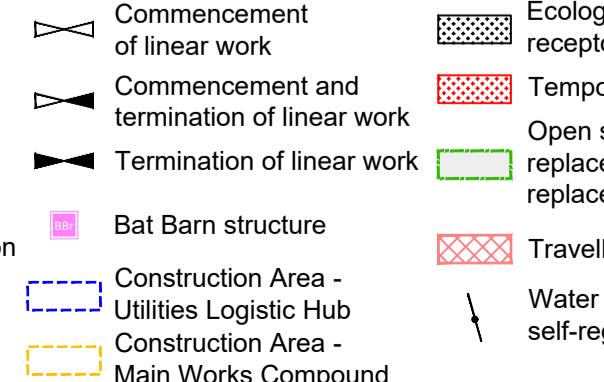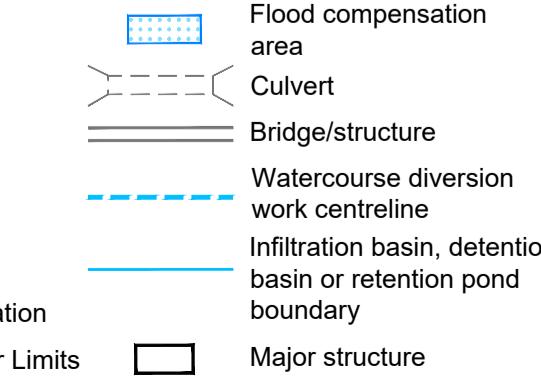

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The image shows the National Highways logo at the top right, featuring a blue stylized road icon followed by the text "national highways". To the left, there is a vertical column with the word "Client" at the top, followed by a map of the Lower Thames Crossing area, and the word "Project" below it. At the bottom, the text "LOWER THAMES CROSSING" is prominently displayed.

Status	DCO Application		Original Size A1	Revision P02
Application Document Number	TR010032/APP/2.6		Scale 1:2500	
Drawing title	<h1 style="text-align: center;">WORKS PLANS</h1> <h2 style="text-align: center;">REGULATION 5(2)(j)</h2> <h3 style="text-align: center;">SHEET 4 - COMPOSITE</h3>			
Drawing Number	HE540039-CJV-BOP-SZZ GN000000 -DR-CX-20002			

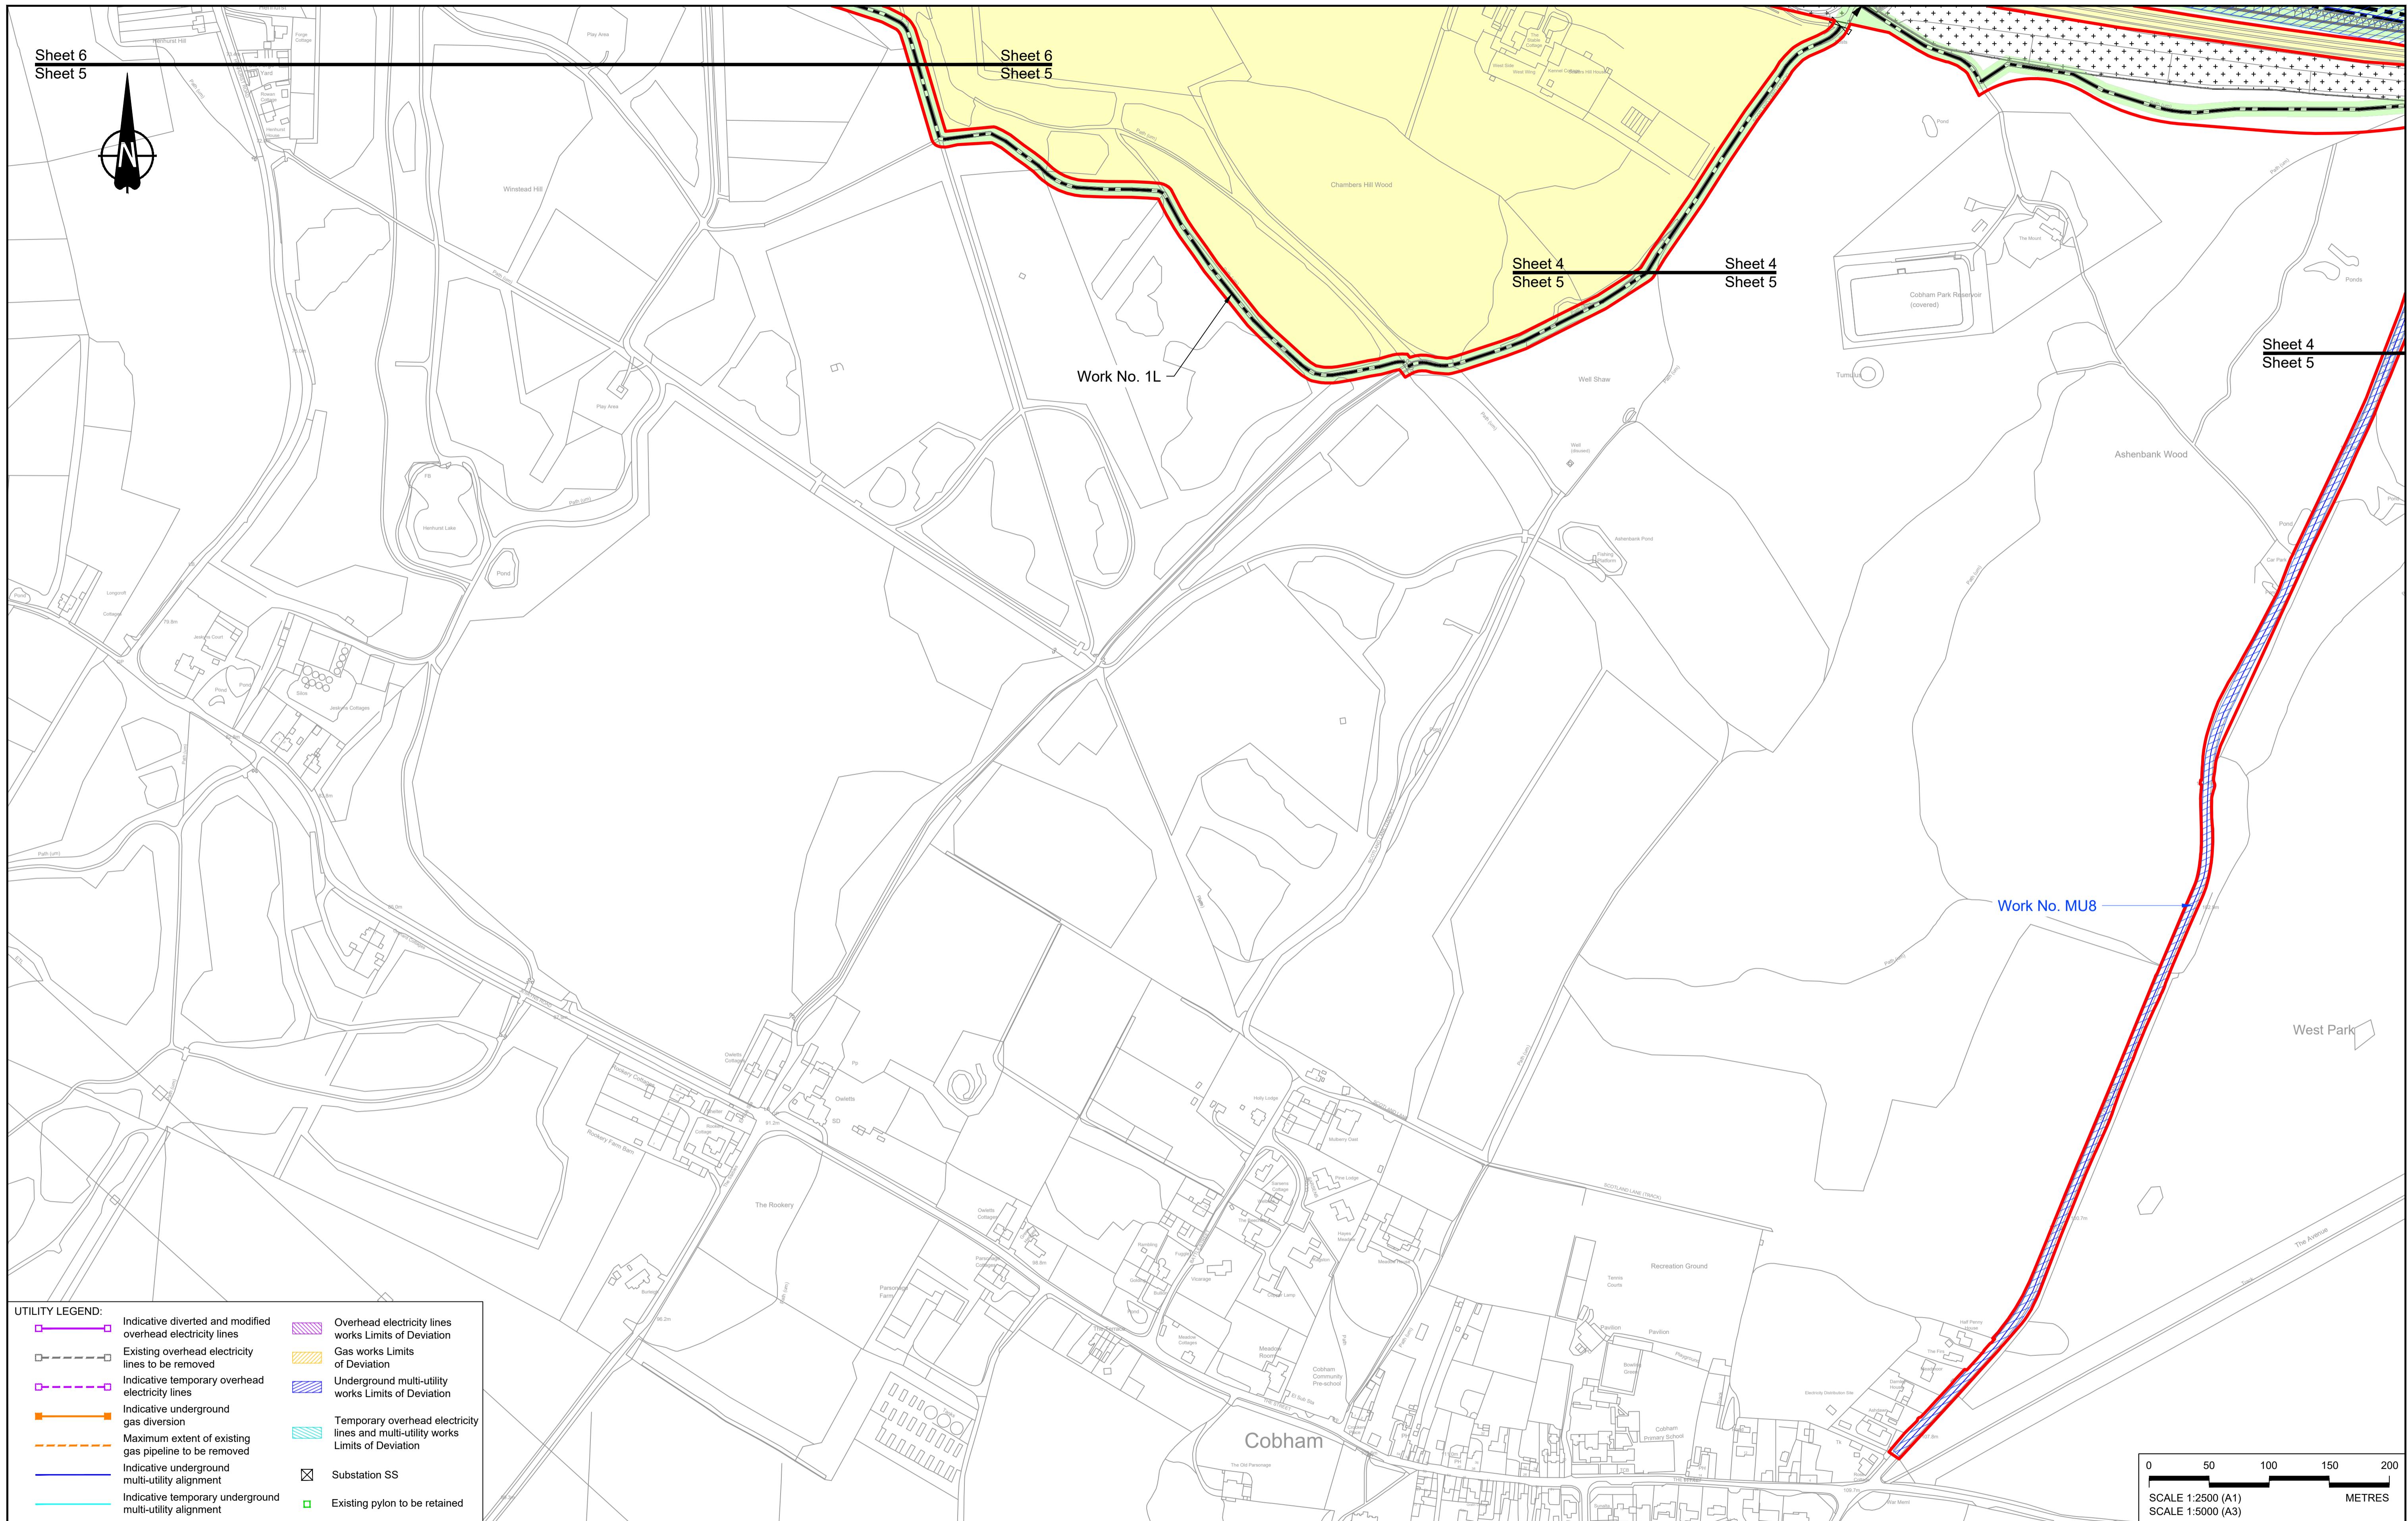

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 - These plans should be read in conjunction with Schedule 1 (Authorised Development) of the Development Consent Order (application document reference TR010032/APP/3.1), the Land Plans (application document reference TR010032/APP/2.2) and the Engineering Drawings and Sections (application document reference TR010032/APP/2.9).
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LEGEND:

- Order Limits
- Linear Work Centreline (including streets)
- Local Authority boundary
- Highway Work (includes structures) Limits of Deviation
- Area excluded from Order Limits
- Flood compensation area
- Culvert
- Bridge/structure
- Watercourse diversion work centreline
- Infiltration basin, detention basin or retention pond boundary
- Major structure
- Commencement of linear work
- Commencement and termination of linear work
- Termination of linear work
- Bat Barn structure
- Construction Area - Utilities Logistic Hub
- Construction Area - Main Works Compound
- Ecological habitat creation and receptor site for protected species
- Temporary ecological habitat
- Open space provision, replacement open space or replacement common land
- Travellers site
- Water inlet with self-regulating valve

Client: national highways

Status: DCO Application

Original Size: A1

Revision: P01

Application Document Number: TR010032/APP/2.6

Scale: 1:2500

Drawing title:

Project:

Drawing Number:

HE540039-CJV-BOP-SZZ_GN000000_DR-CX-20003


WORKS PLANS

REGULATION 5(2)(j)

SHEET 5 - COMPOSITE

Drawing Number:

HE540039-CJV-BOP-SZZ_GN000000_DR-CX-20003.dwg

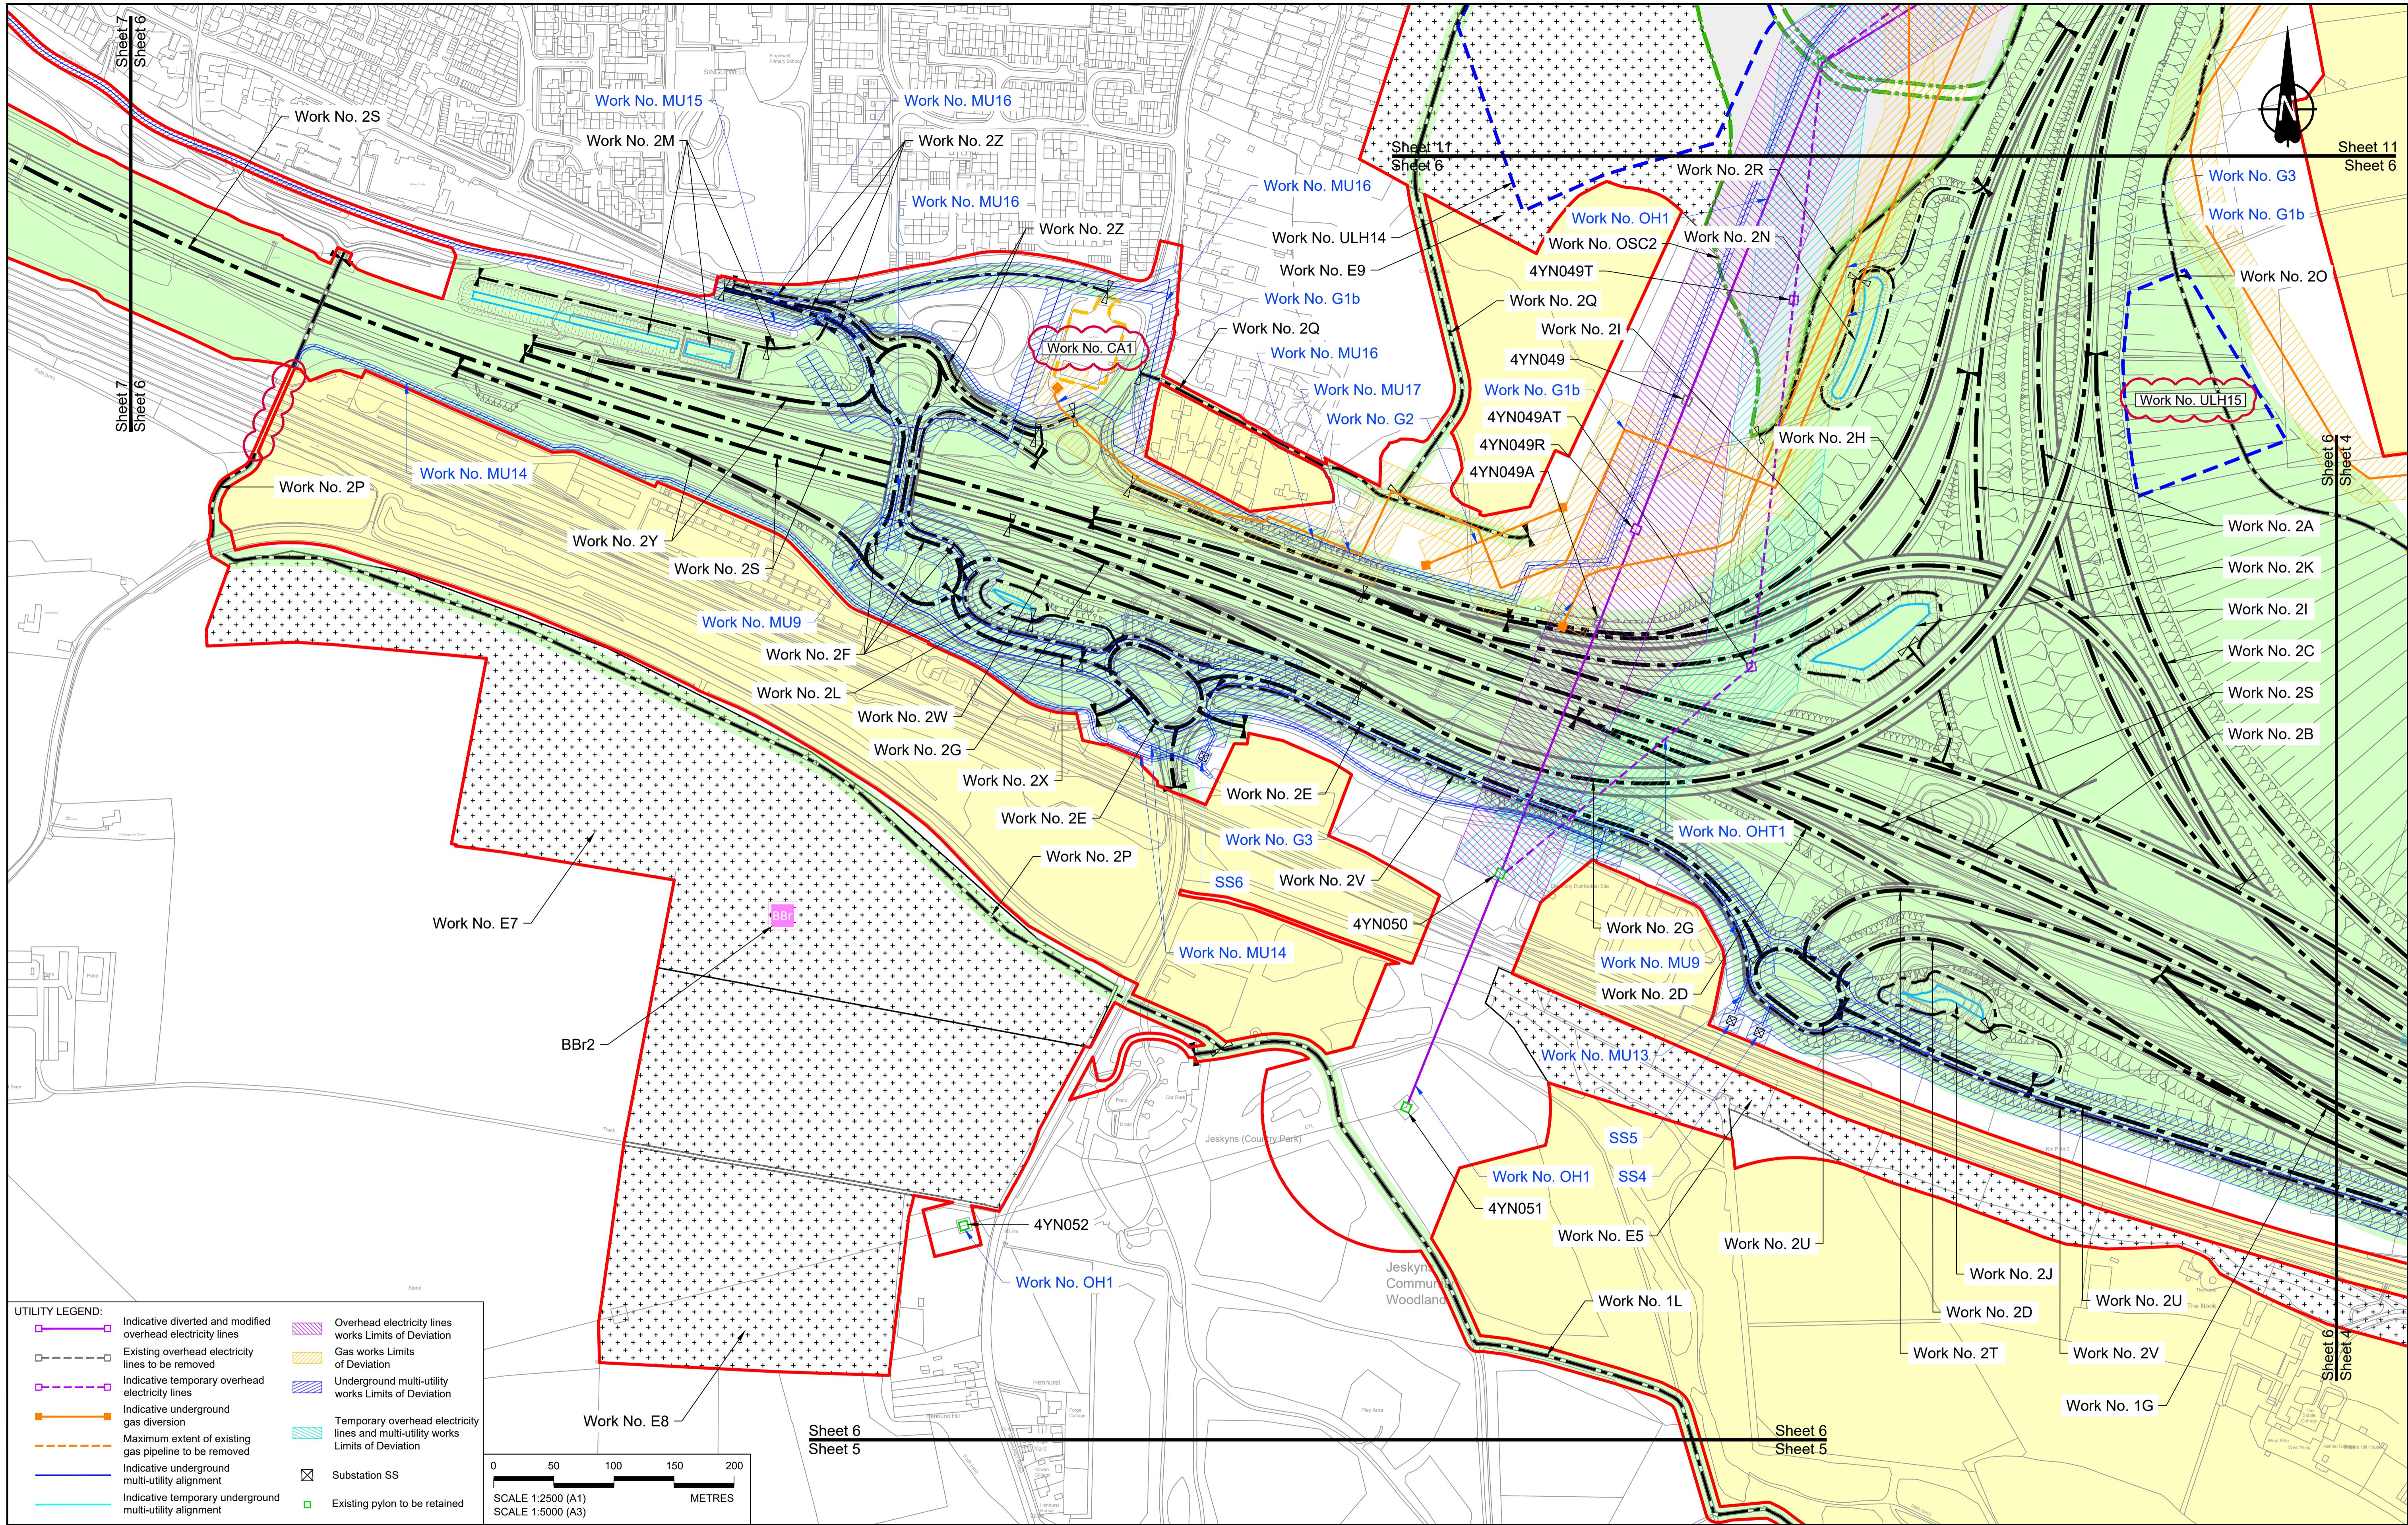

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NOTES:					
P01	S8	19/10/2022	DCO Application	MS	RO ASB
P02	S8	13/12/2022	Revision following S51 advice	MS	RO ASB
Rev	Status	Rev. Date	Purpose of revision	Drawn	Chk'd Apprv'd

LEGEND:

- Order Limits
- Linear Work Centreline (including streets)
- Local Authority boundary
- Highway Work (includes structures) Limits of Deviation

1. The proposed works shown are illustrative only and will be subject to change as part of detailed design development. Any changes will be limited to being within the constraints included in the Development Consent Order (application document reference TR010032/APP/3.1).

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3. Proposed works are shown adjacent to the Order Limits to provide greater clarity of the extent of the work but could extend to the Order Limits as well.


4. The definition of streets is included in the Development Consent Order (application document reference TR010032/APP/3.1).

LEGEND:

- Flood compensation area
- Culvert
- Bridge/structure
- Watercourse diversion work centreline
- Infiltration basin, detention basin or retention pond boundary
- Major structure
- Commencement of linear work
- Commencement and termination of linear work
- Termination of linear work
- Bat Barn structure
- Construction Area - Utilities Logistic Hub
- Construction Area - Main Works Compound
- Ecological habitat creation and receptor site for protected species
- Temporary ecological habitat
- Open space provision, replacement open space or replacement common land
- Travellers site
- Water inlet with self-regulating valve
- Client
- Project
- Status

DCO Application
Application Document Number: TR010032/APP/2.6
Scale: 1:2500

WORKS PLANS
REGULATION 5(2)(j)
SHEET 6 - COMPOSITE

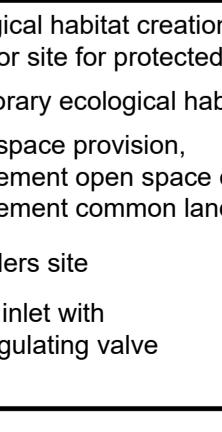

Client:
national highways

Project:
LOWER THAMES CROSSING

Status:
Drawing Number: HE540039-CJV-BOP-SZZ_GN000000_DR-CX-20004

Original Size: A1

Revision: P02

Scale: 1:2500

Drawing title:

Project:

Status:


Original Size:

Revision:

Scale:

Date:

Version:

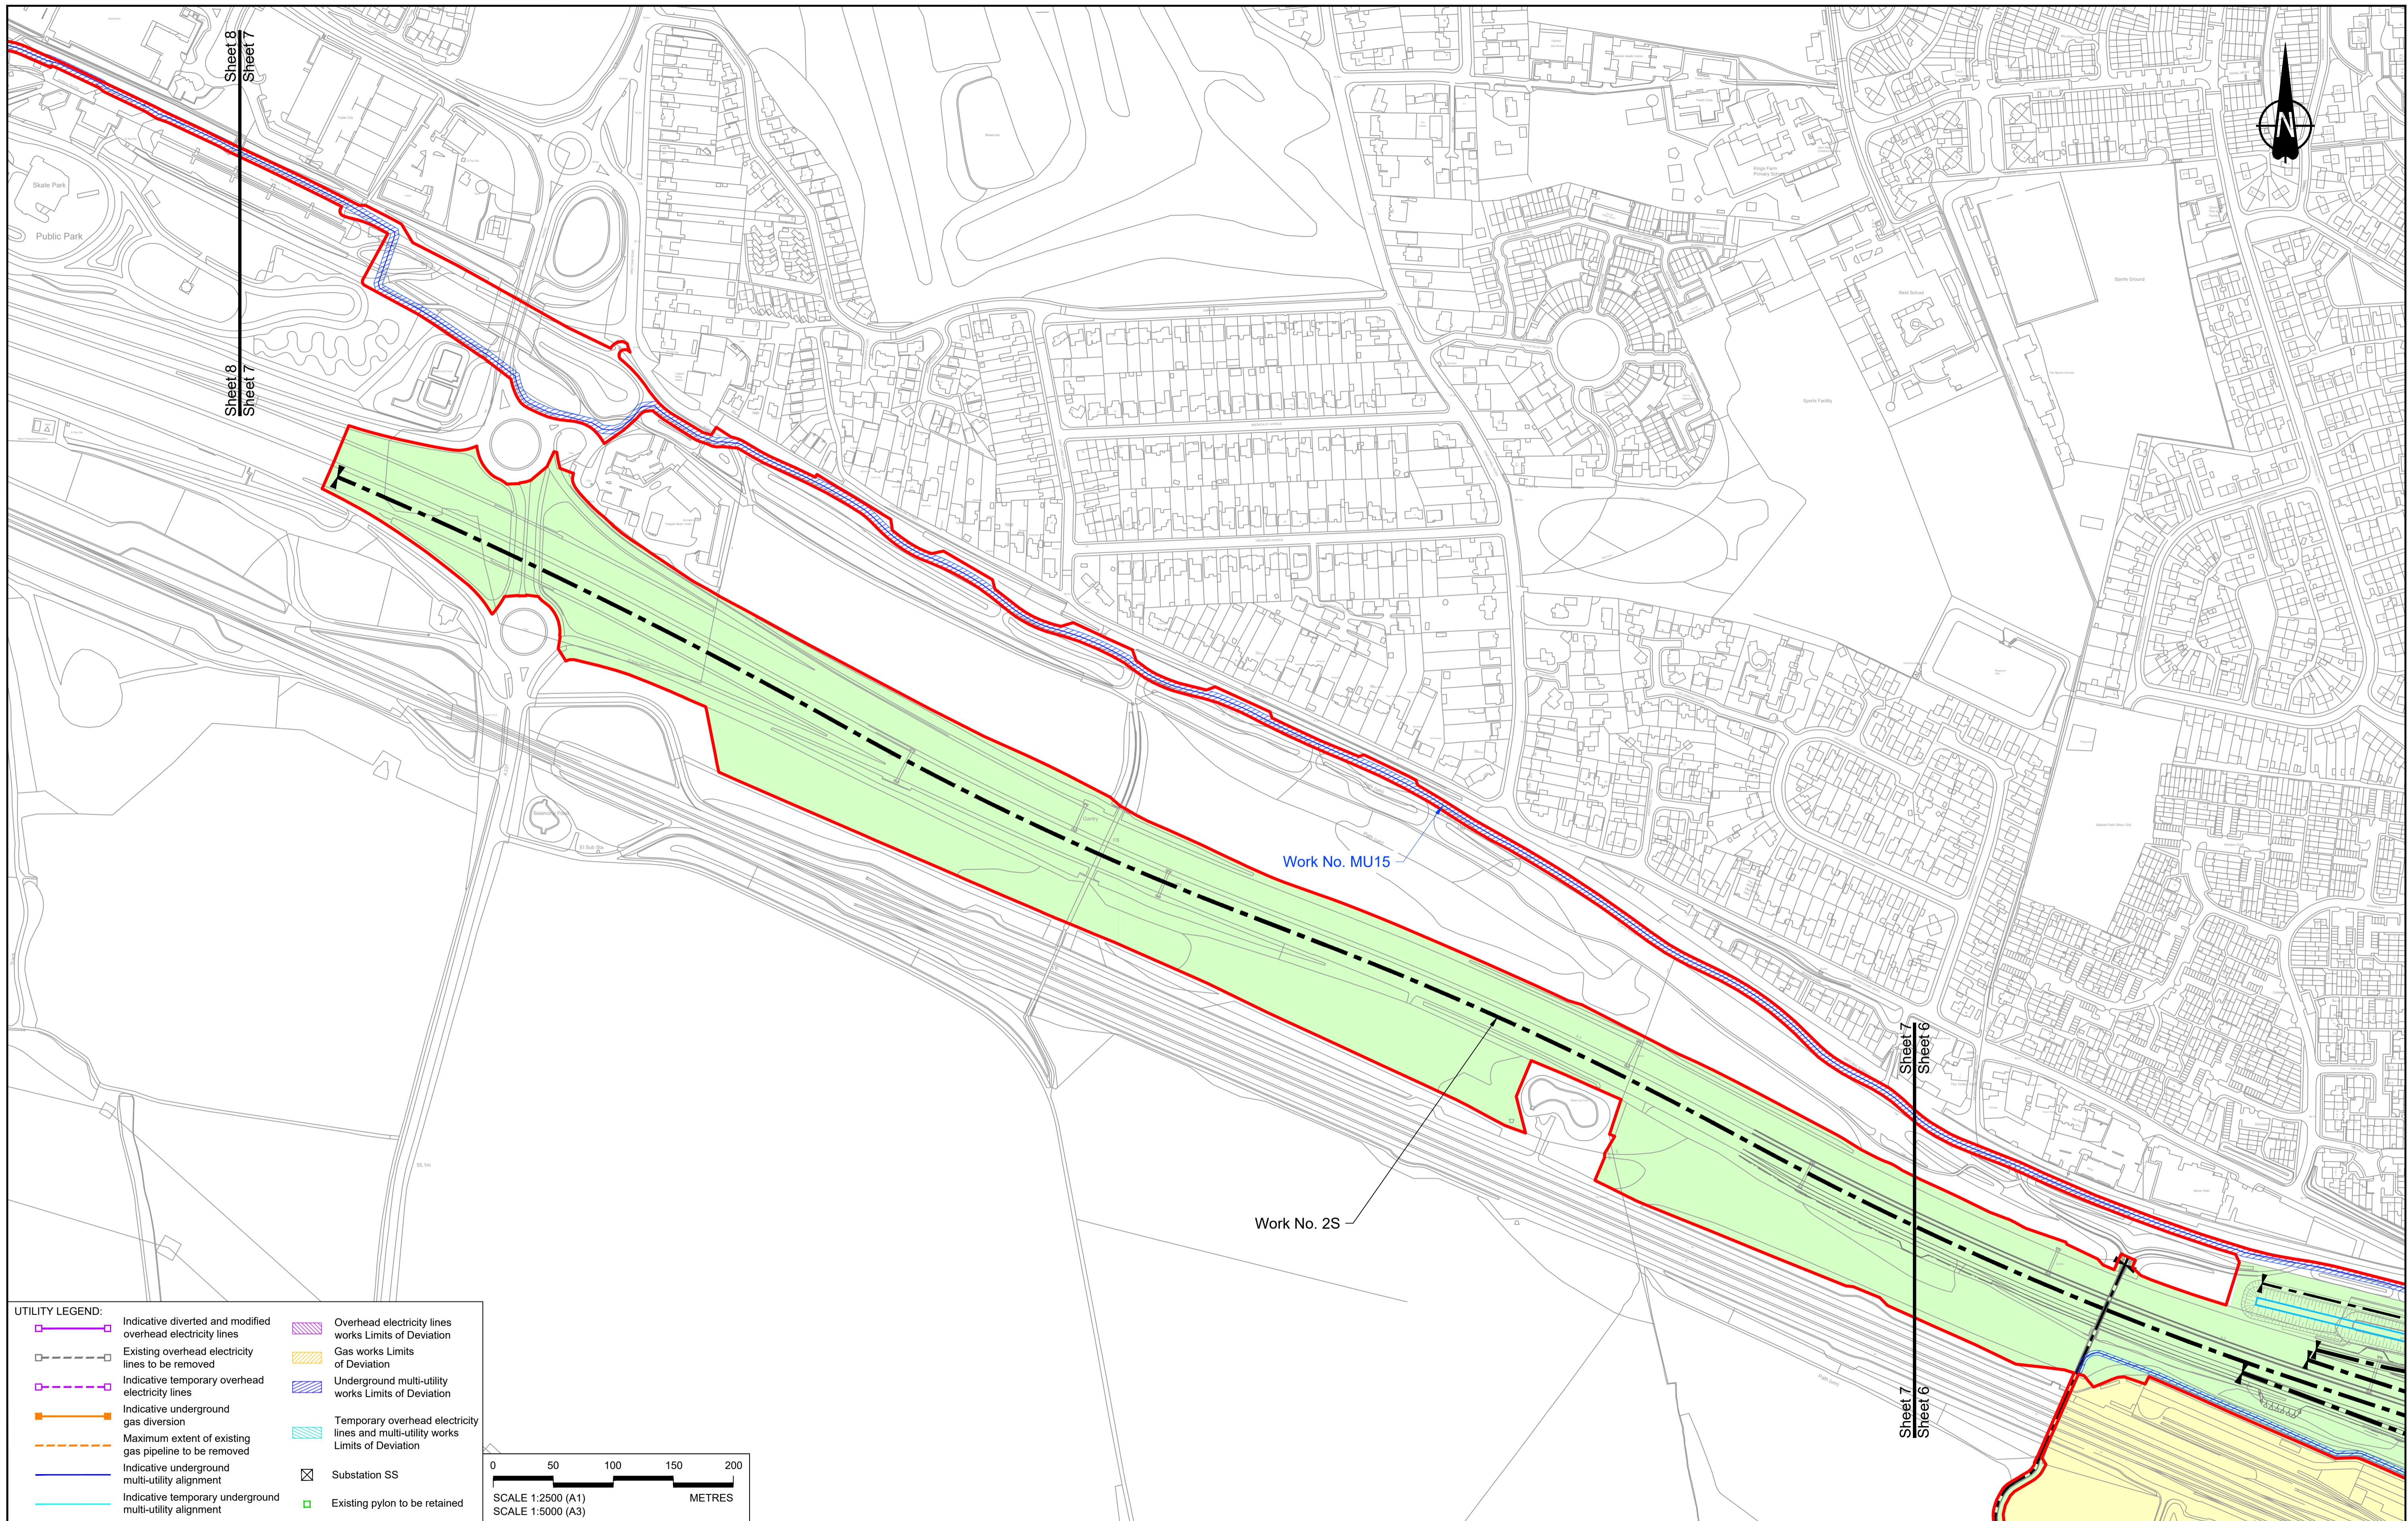

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- LEGEND:**
- Order Limits
 - Linear Work Centreline (including streets)
 - Local Authority boundary
 - Highway Work (includes structures) Limits of Deviation
 - Flood compensation area
 - Culvert
 - Bridge/structure
 - Watercourse diversion work centreline
 - Infiltration basin, detention basin or retention pond boundary
 - Major structure
 - Commencement of linear work
 - Commencement and termination of linear work
 - Termination of linear work
 - Bat Barn structure
 - Construction Area - Utilities Logistic Hub
 - Construction Area - Main Works Compound
 - Ecological habitat creation and receptor site for protected species
 - Temporary ecological habitat
 - Open space provision, replacement open space or replacement common land
 - Travellers site
 - Water inlet with self-regulating valve

P01 S8 19/10/2022 DCO Application MS RO ASB

Rev

Status

Rev. Date

Purpose of revision


Drawn


Chk'd

Apprv'd

national highways
DCO Application
Application Document Number: TR010032/APP/2.6
Drawing title: WORKS PLANS
REGULATION 5(2)(j)
SHEET 7 - COMPOSITE
Project: LOWER THAMES CROSSING

Status: A1 Original Size: P01 Revision: P01
Scale: 1:2500
Drawing Number: HE540039-CJV-BOP-SZZ_GN000000_DR-CX-20005
HE540039-CJV-BOP-SZZ_GN000000_DR-CX-20005.dwg

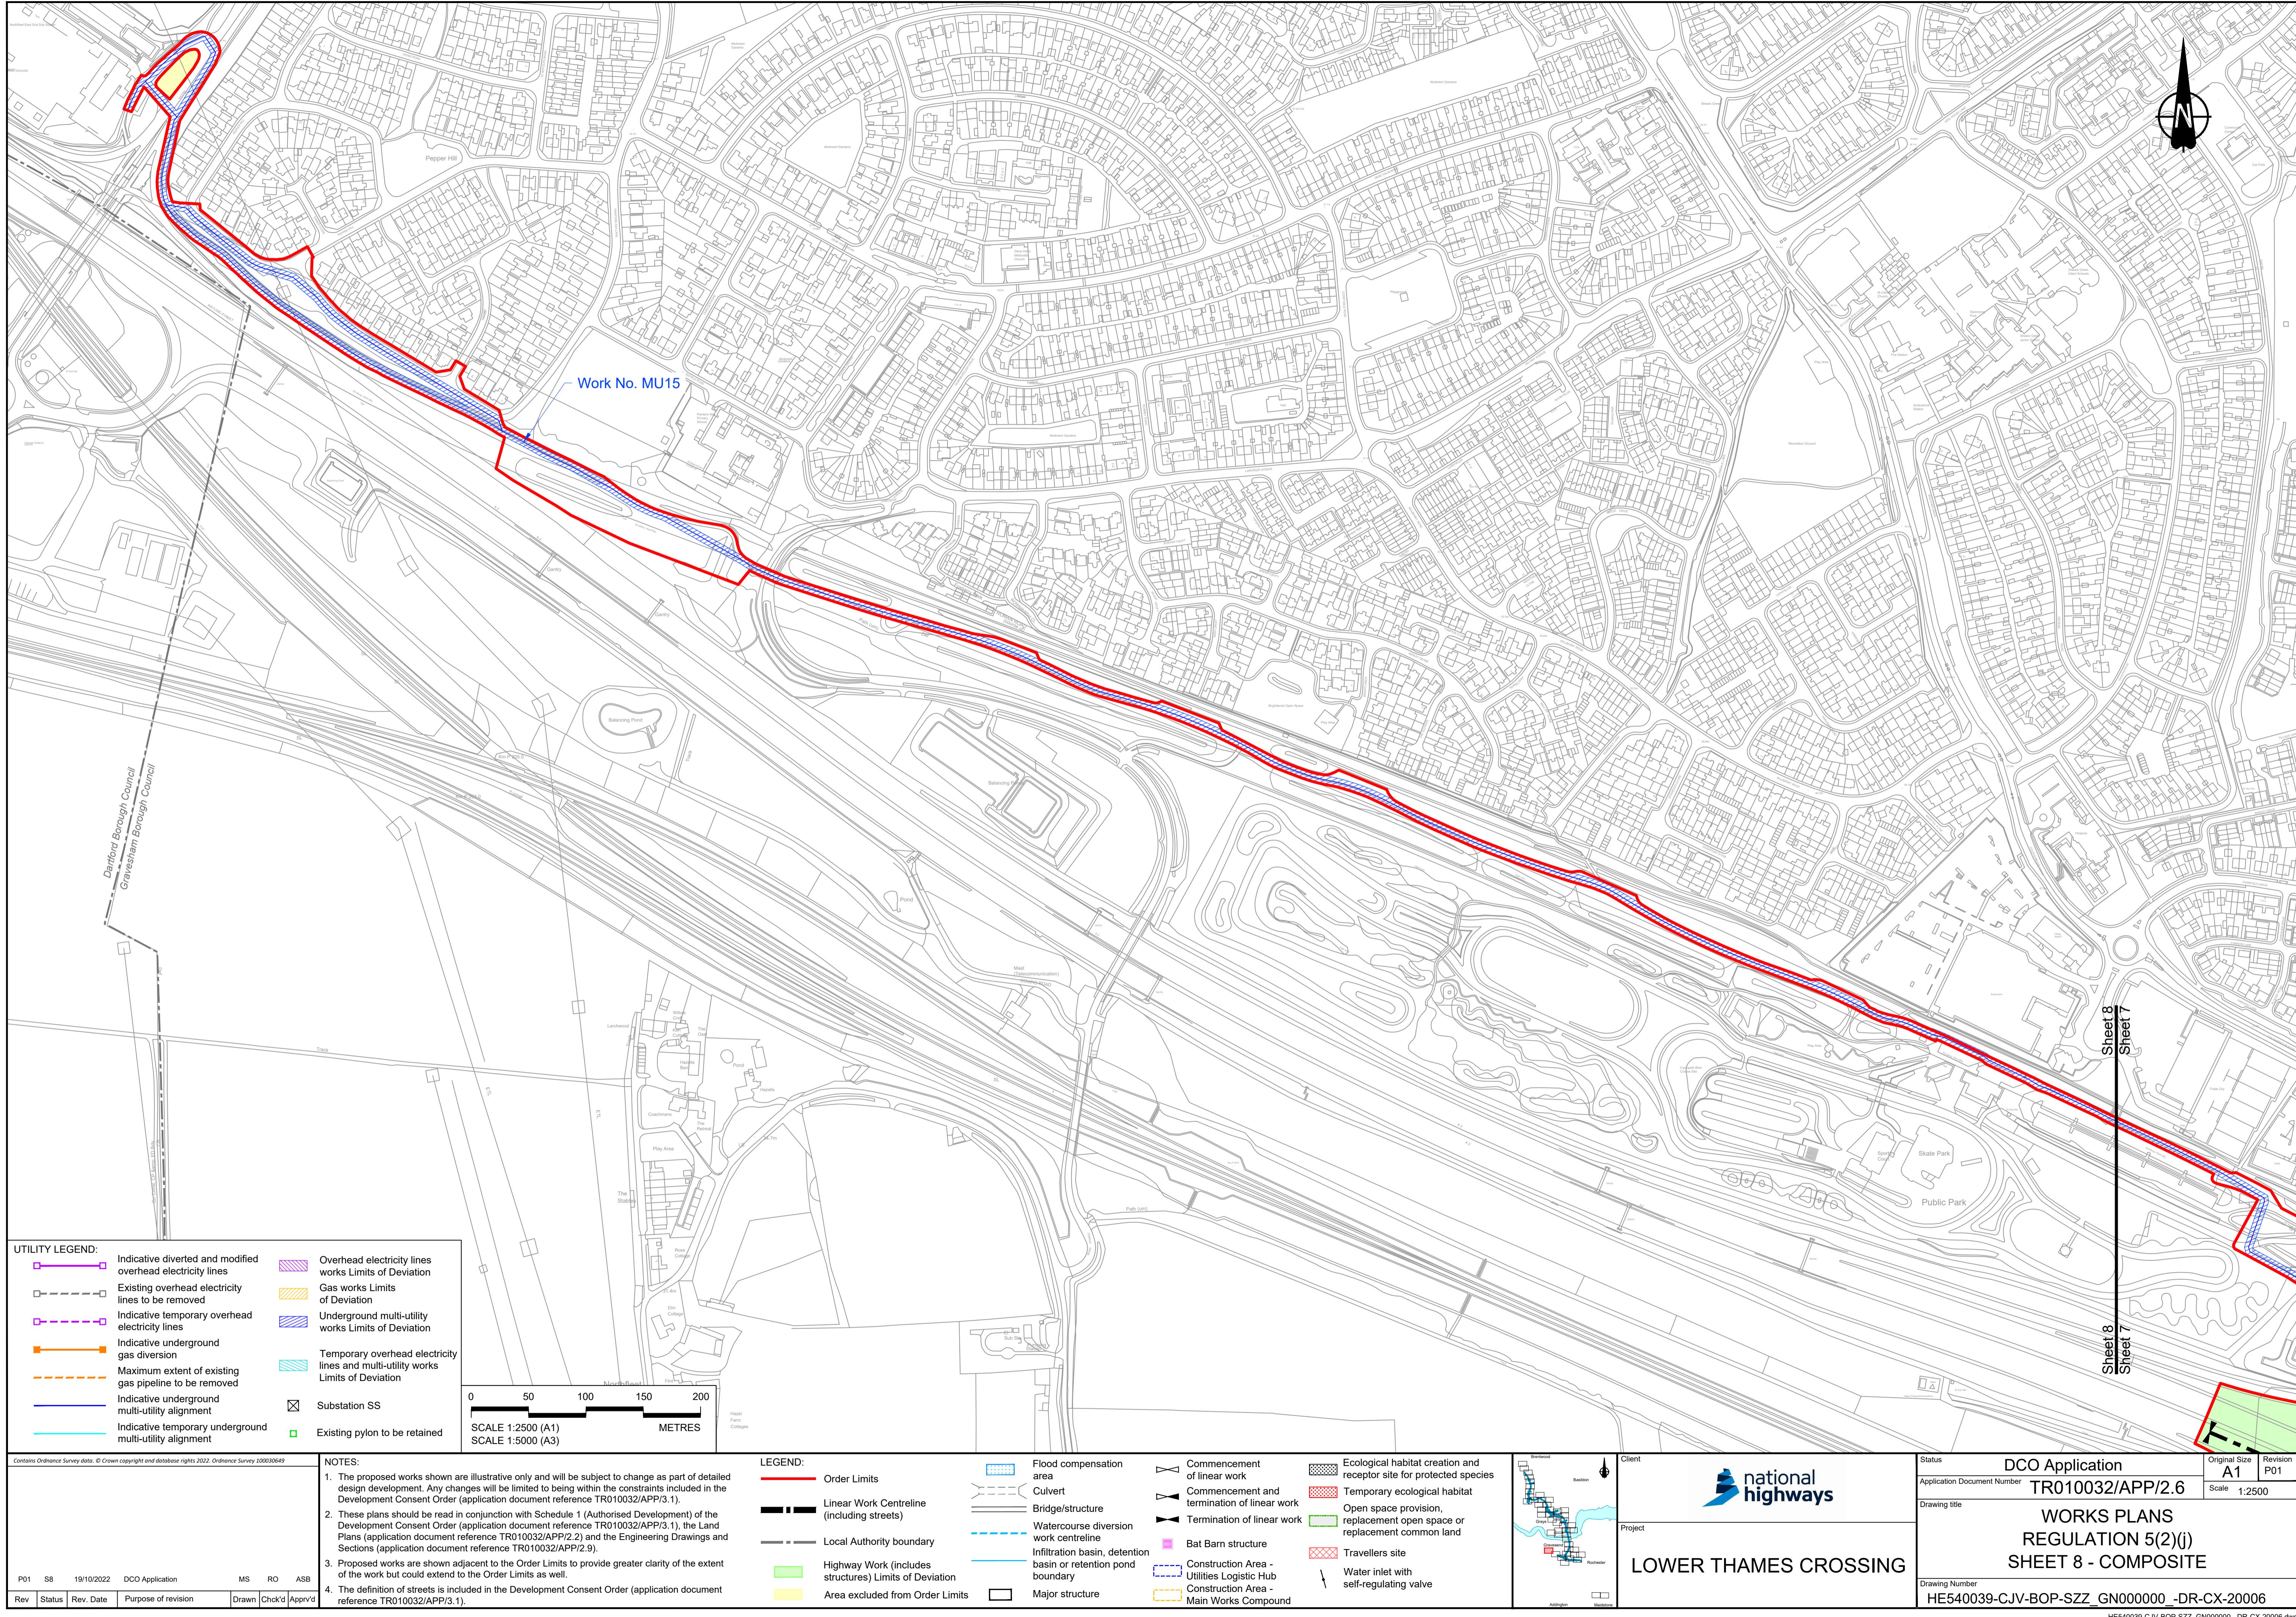

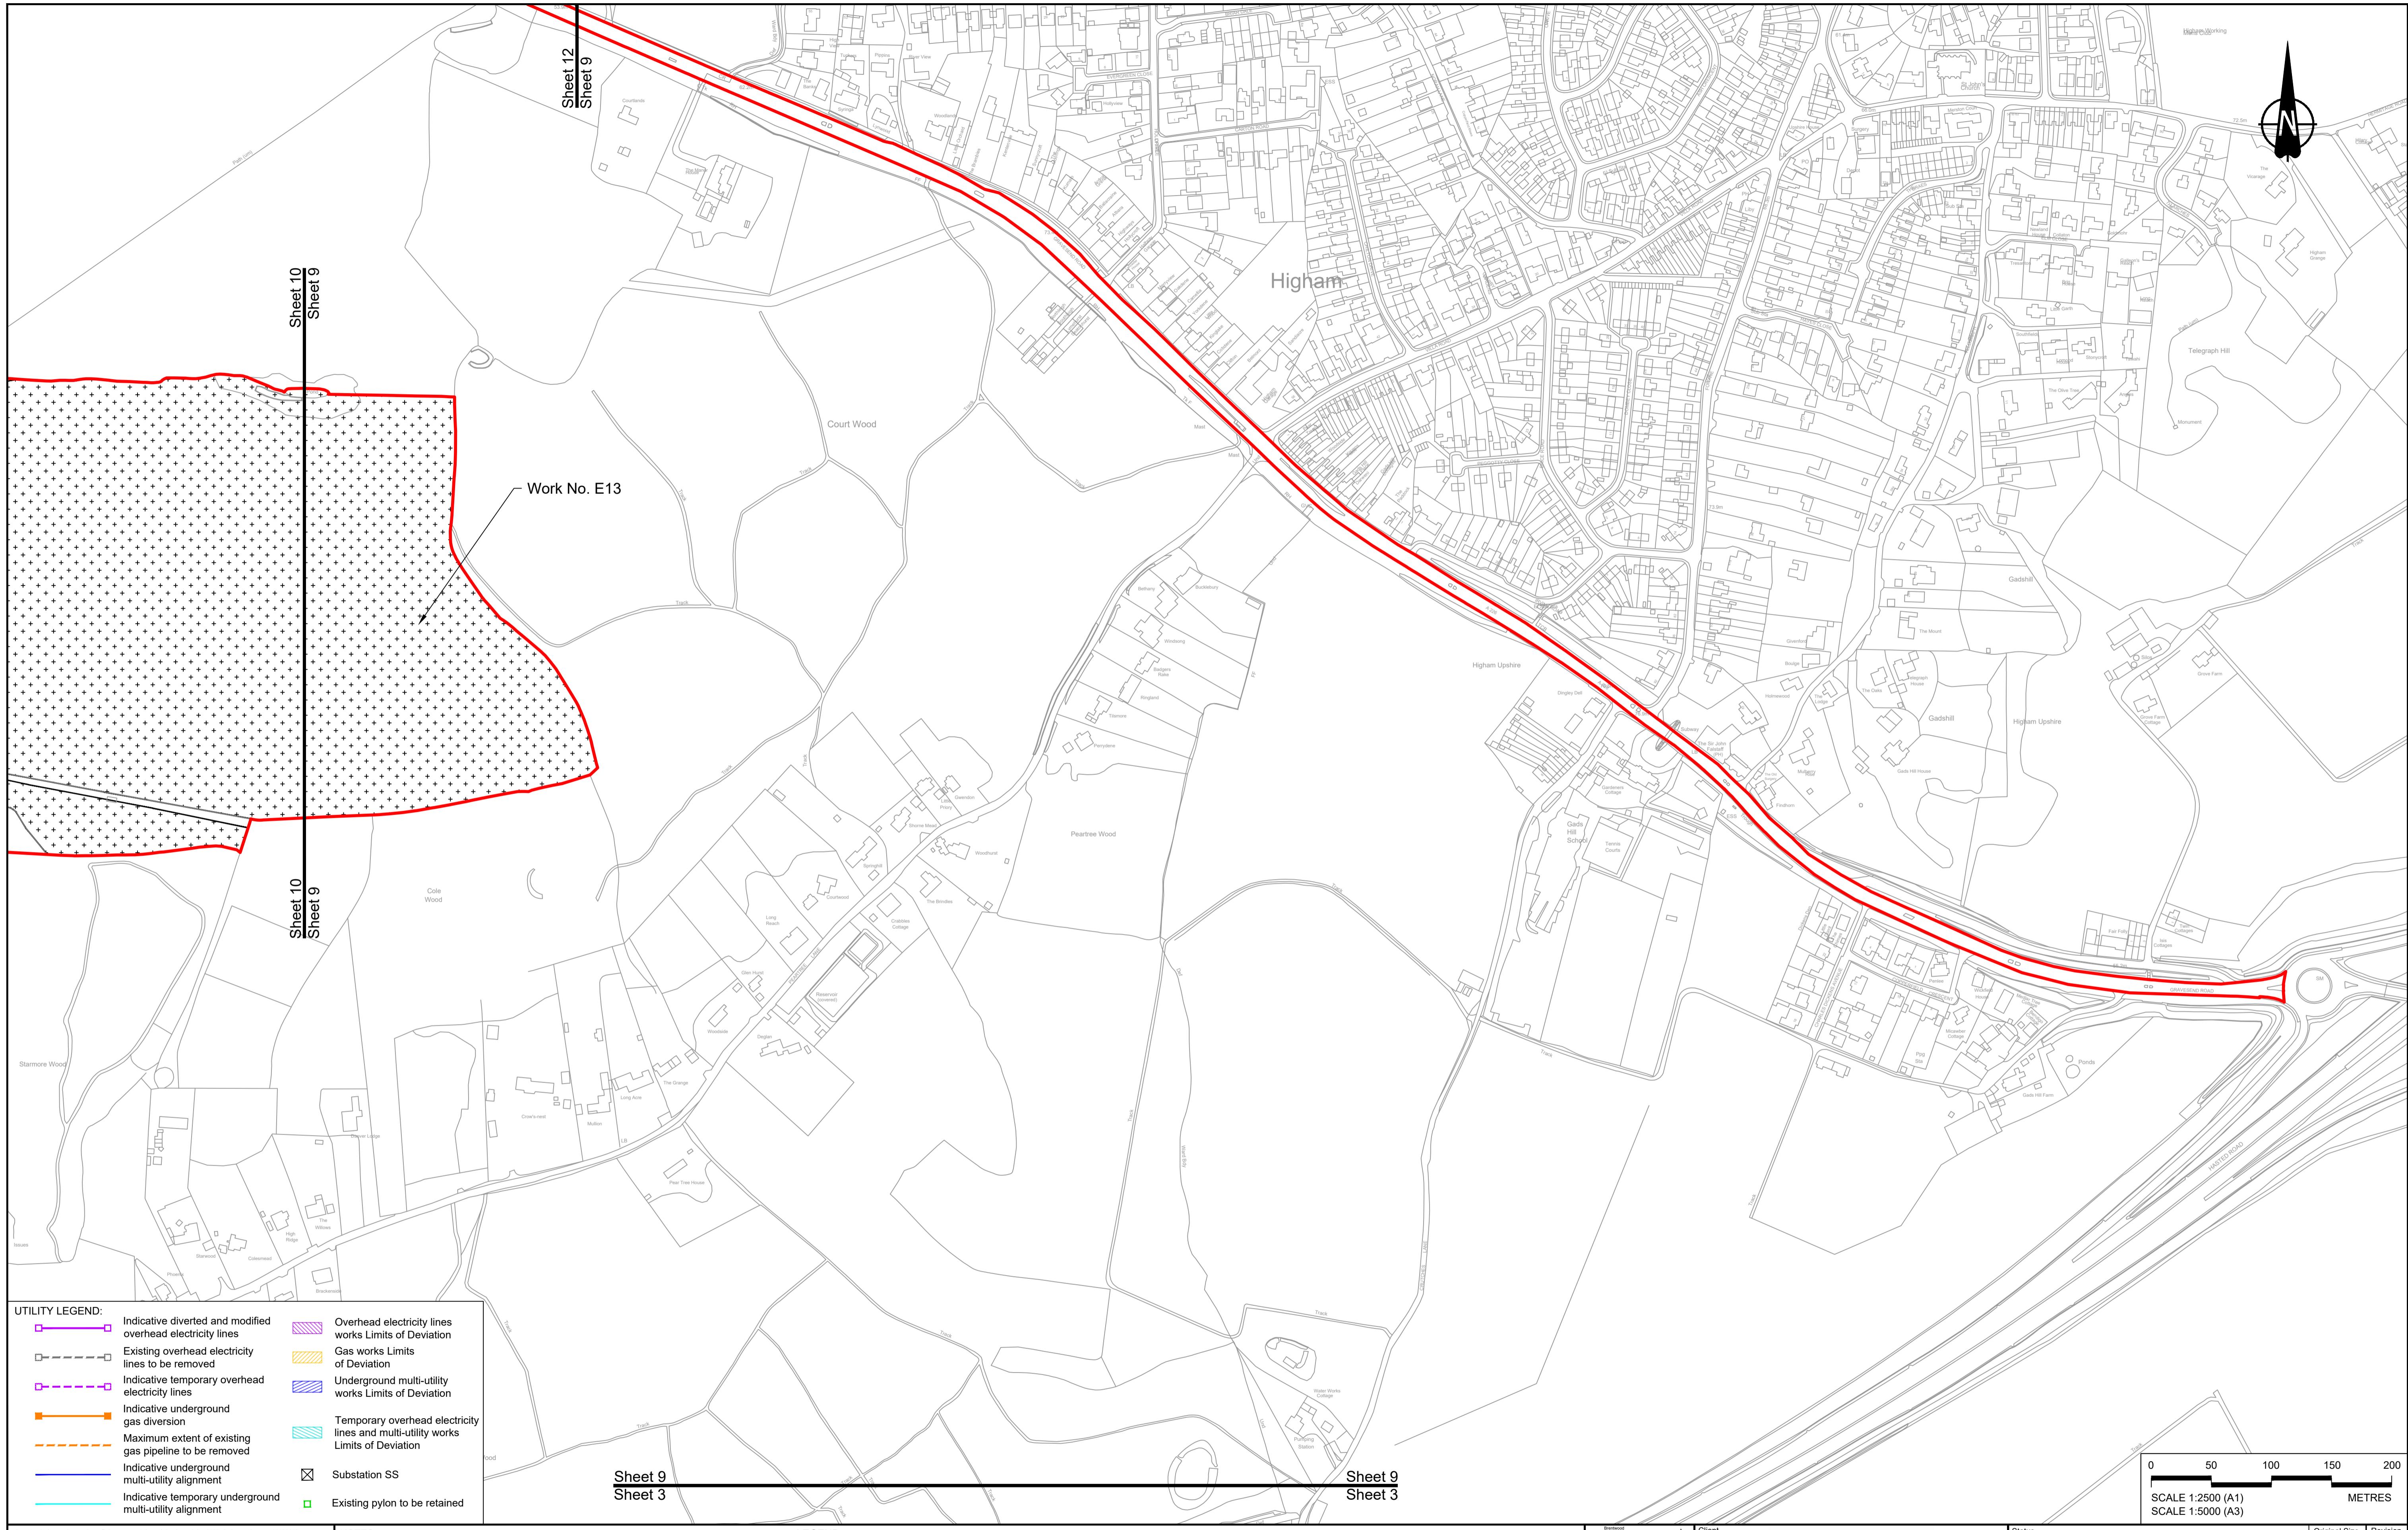

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P01 S8 19/10/2022 DCO Application MS RO ASB

Rev

Status

Rev. Date

Purpose of revision

Drawn

Chk'd

Apprv'd

- NOTES:
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LEGEND:

- Order Limits
- Linear Work Centreline (including streets)
- Local Authority boundary
- Highway Work (includes structures) Limits of Deviation
- Flood compensation area
- Culvert
- Bridge/structure
- Watercourse diversion work centreline
- Infiltration basin, detention basin or retention pond boundary
- Area excluded from Order Limits
- Commencement of linear work
- Commencement and termination of linear work
- Termination of linear work
- Bat Barn structure
- Construction Area - Utilities Logistic Hub
- Construction Area - Main Works Compound
- Ecological habitat creation and receptor site for protected species
- Temporary ecological habitat
- Open space provision, replacement open space or replacement common land
- Travellers site
- Water inlet with self-regulating valve
- Major structure

Client

Project

LOWER THAMES CROSSING

Status

DCO Application

Original Size

A1

Revision

P01

Application Document Number

TR010032/APP/2.6

Scale

1:2500

Drawing title

WORKS PLANS

REGULATION 5(2)(j)


SHEET 9 - COMPOSITE

Drawing Number

HE540039-CJV-BOP-SZZ_GN000000

-DR-CX-20007


HE540039-CJV-BOP-SZZ_GN000000_DR-CX-20007.dwg

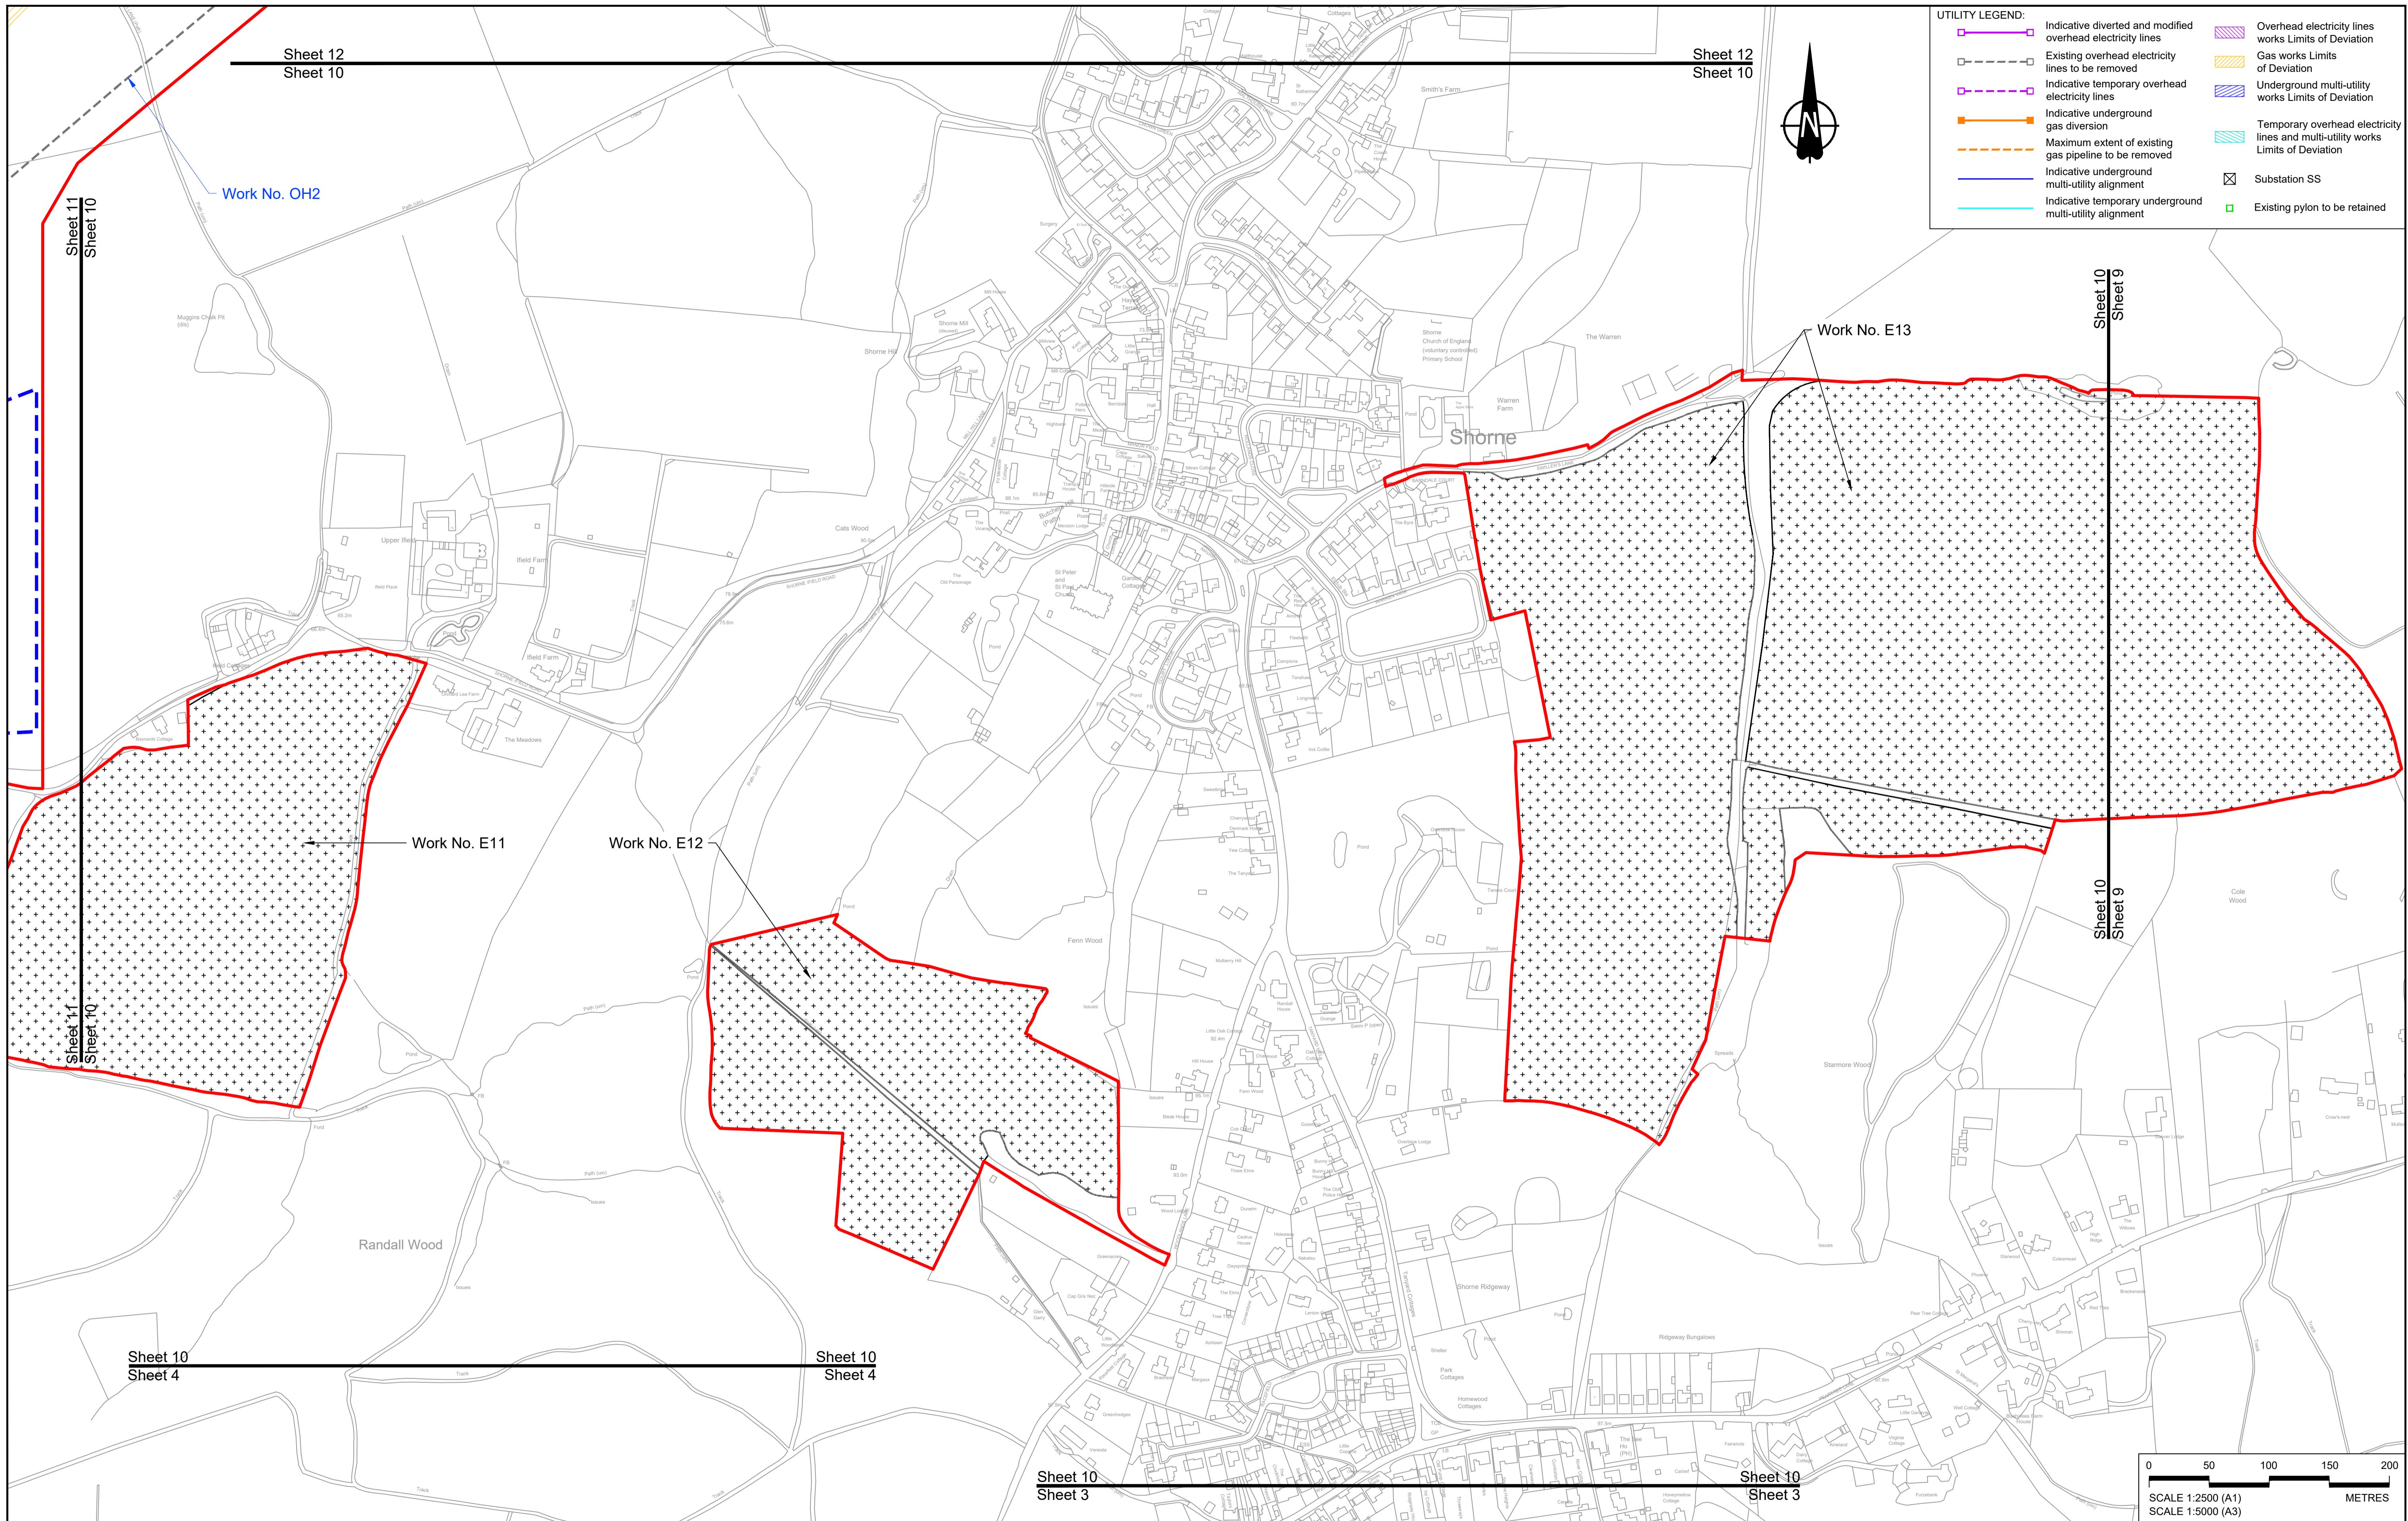

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- LEGEND:**
- | | | | |
|--|--|---|---|
| Order Limits | Flood compensation area | Commencement of linear work | Ecological habitat creation and receptor site for protected species |
| Linear Work Centreline (including streets) | Culvert | Commencement and termination of linear work | Temporary ecological habitat |
| Local Authority boundary | Bridge/structure | Termination of linear work | Open space provision, replacement open space or replacement common land |
| Highway Work (includes structures) Limits of Deviation | Watercourse diversion work centreline | Bat Barn structure | Bat Barn structure |
| Highway Work (includes structures) Limits of Deviation | Infiltration basin, detention basin or retention pond boundary | Construction Area - Utilities Logistic Hub | Travellers site |
| Area excluded from Order Limits | Major structure | Construction Area - Main Works Compound | Water inlet with self-regulating valve |



Client

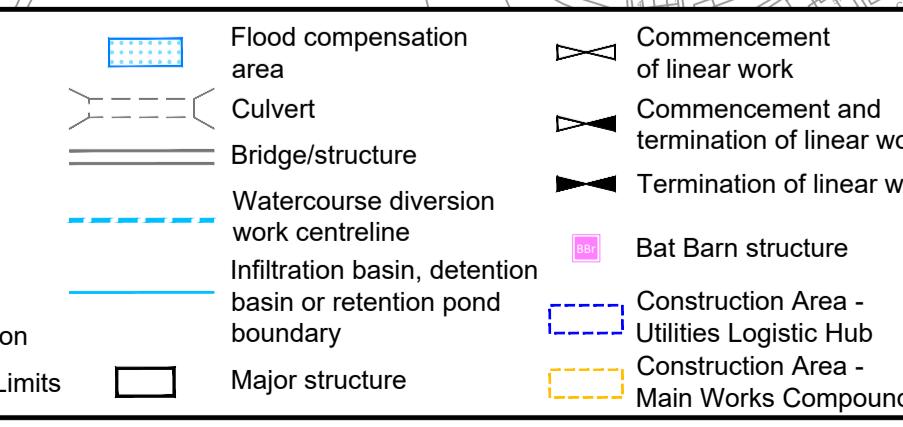


DCO Application
Application Document Number: TR010032/APP/2.6
Original Size: A1
Revision: P01
Scale: 1:2500
WORKS PLANS
REGULATION 5(2)(j)
SHEET 10 - COMPOSITE

Drawing Number: HE540039-CJV-BOP-SZZ_GN0000000_DR-CX-20008

P01 S8 19/10/2022 DCO Application MS RO ASB

Rev Status Rev. Date Purpose of revision Drawn Chkd Apprv'd

HE540039-CJV-BOP-SZZ_GN0000000_DR-CX-20008.dwg

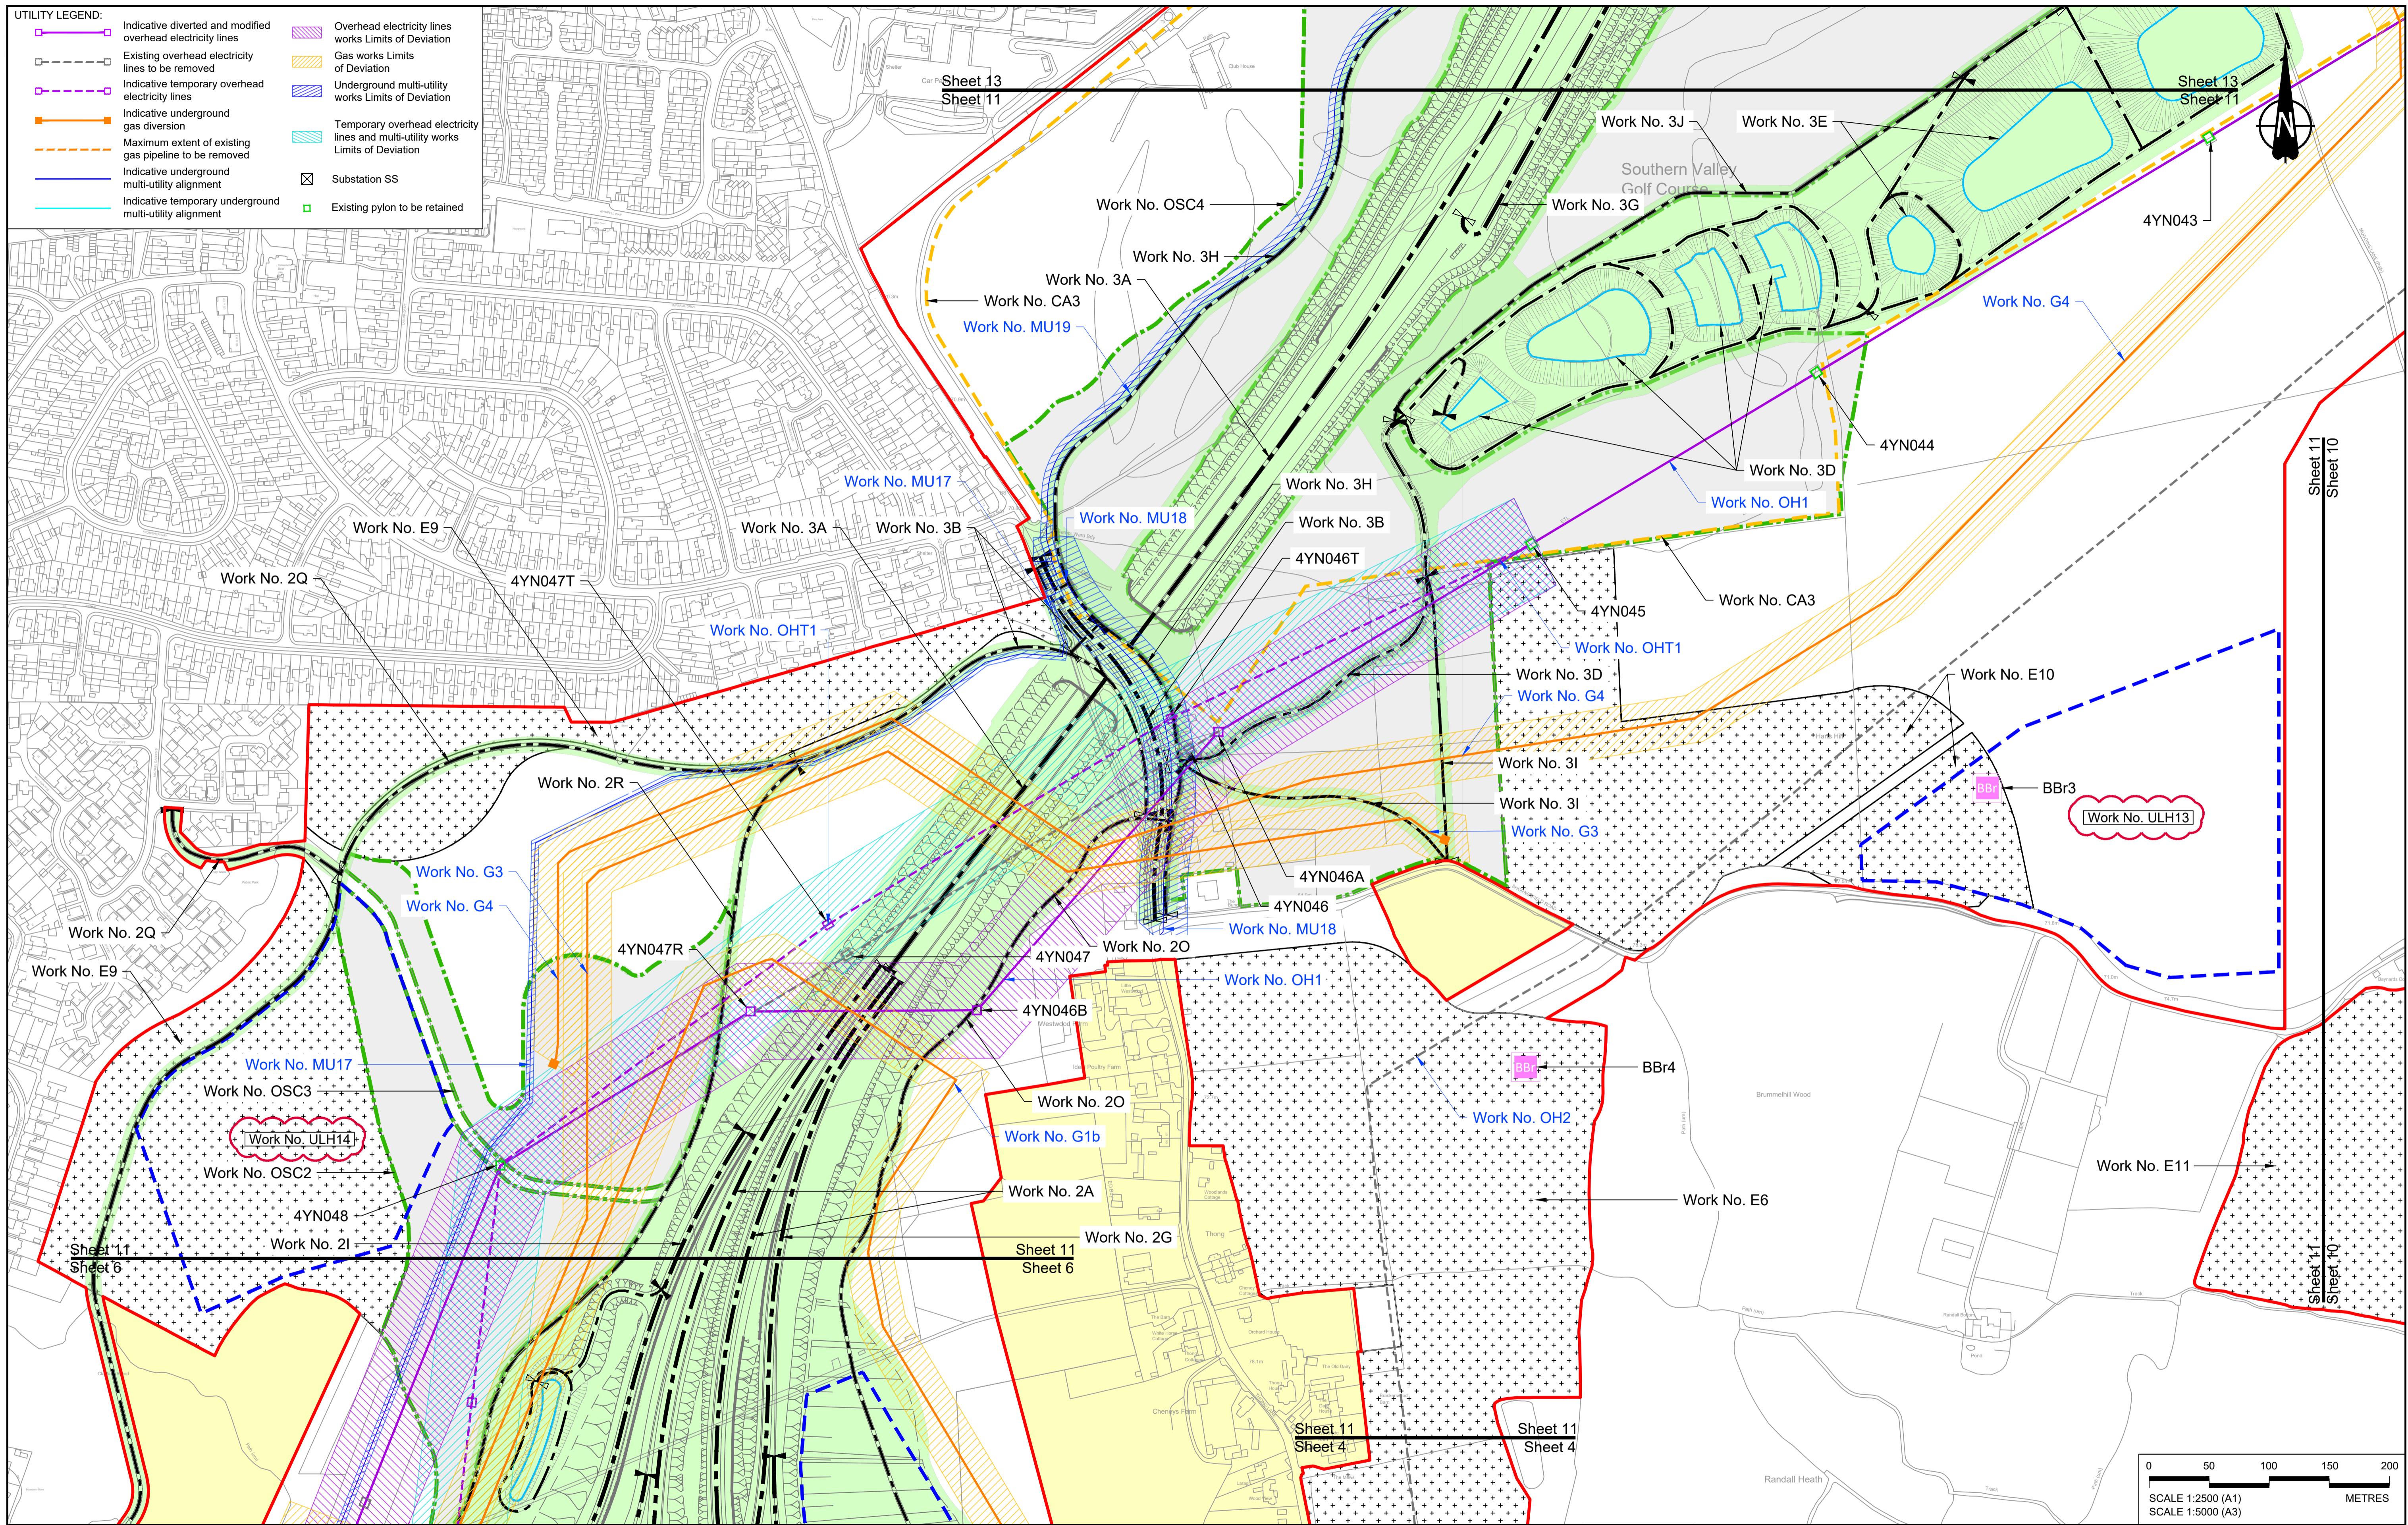

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LEGEND:

Order Limits	Flood compensation area	Commencement of linear work	Ecological habitat creation and receptor site for protected species
Linear Work Centreline (including streets)	Culvert	Commencement and termination of linear work	Temporary ecological habitat
Local Authority boundary	Bridge/structure	Termination of linear work	Open space provision, replacement open space or replacement common land
Highway Work (includes structures) Limits of Deviation	Watercourse diversion work centreline	Infiltration basin, detention basin or retention pond boundary	Bat Barn structure
Area excluded from Order Limits	Major structure	Construction Area - Utilities Logistic Hub	Travellers site

Flood compensation area
 Culvert
 Bridge/structure
 Watercourse diversion work centreline
 Infiltration basin, detention basin or retention pond boundary
 Major structure

Commencement of linear work
 Commencement and termination of linear work
 Termination of linear work
 Ecological habitat creation and receptor site for protected species
 Temporary ecological habitat
 Open space provision, replacement open space or replacement common land
 Bat Barn structure
 Construction Area - Utilities Logistic Hub
 Construction Area - Main Works Compound


Client



DCO Application
Application Document Number: TR010032/APP/2.6
Scale: 1:2500
WORKS PLANS
REGULATION 5(2)(j)
SHEET 11 - COMPOSITE
Drawing Number: HE540039-CJV-BOP-SZZ_GN000000_DR-CX-20009

P01 S8 19/10/2022 DCO Application MS RO ASB
P02 S8 13/12/2022 Revision following S51 advice MS RO ASB
Rev Status Rev. Date Purpose of revision Drawn Chkd Apprv'd

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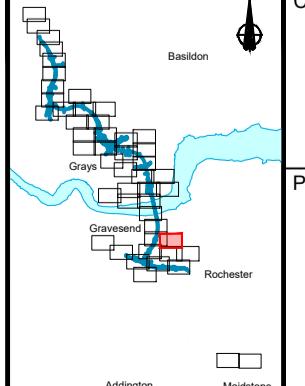
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LEGEND:

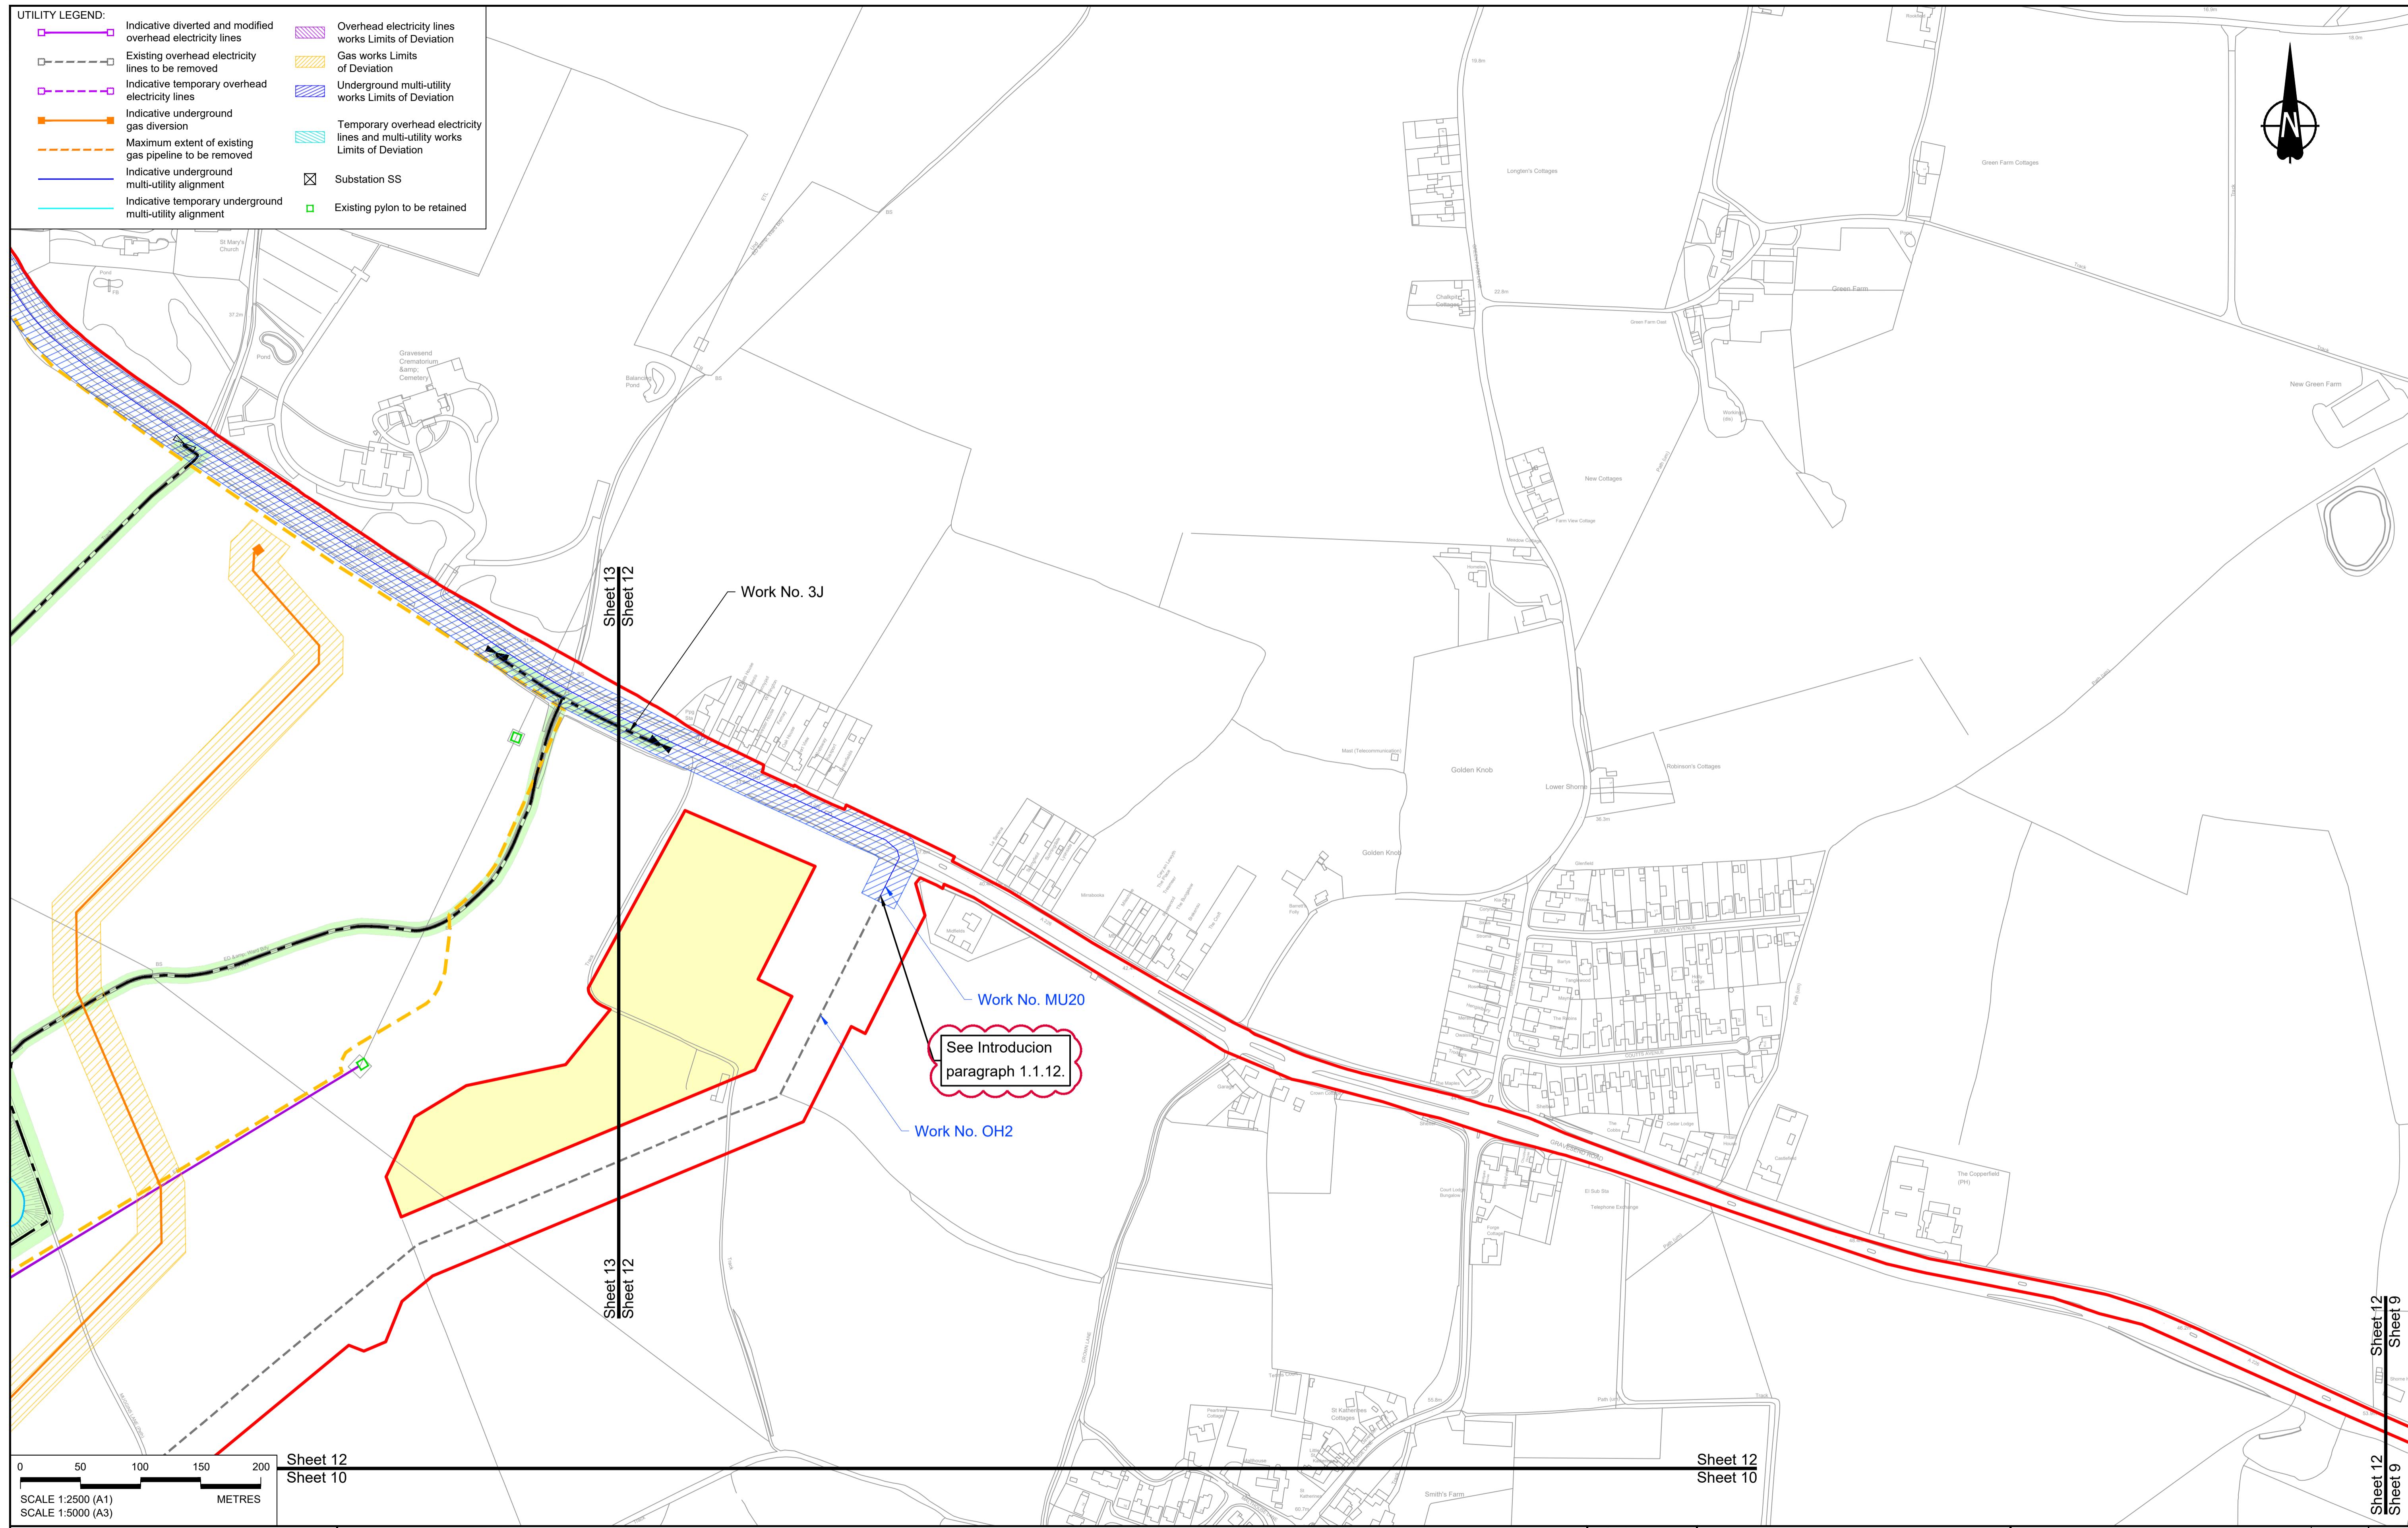- Order Limits**: Red line
- Linear Work Centreline (including streets)**: Black line with white dots
- Local Authority boundaries**: Grey line
- Highway Work (including structures) Limits of D**: Green box
- Area excluded from O**: Yellow box

- The legend consists of two columns of symbols and their corresponding descriptions. The first column contains eight symbols: a blue dotted rectangle for 'Flood compensation area', a grey dashed Y-shape for 'Culvert', a solid grey double line for 'Bridge/structure', a blue dashed line for 'Watercourse diversion work centreline', a blue line for 'Infiltration basin, detention basin or retention pond boundary', a white rectangle for 'Major structure', a black triangle pointing right for 'Commencement of linear work', and a black triangle pointing left for 'Termination of linear work'. The second column contains nine descriptions: 'Ecological habitat creation and receptor site for protected species' (black dotted rectangle), 'Temporary ecological habitat' (red dotted rectangle), 'Open space provision, replacement open space or replacement common land' (green outlined rectangle), 'Travellers site' (red hatched rectangle), 'Water inlet with self-regulating valve' (black outline with a valve symbol), 'Bat Barn structure' (pink square with 'BBr' text), 'Construction Area - Utilities Logistic Hub' (blue dashed rectangle), 'Construction Area - Main Works Compound' (orange dashed rectangle), and 'Major structure' (white rectangle).





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object

LOWER THAMES CROSSING

Status	DCO Application	Original Size A1	Revision P02
Application Document Number	TR010032/APP/2.6	Scale 1:2500	
Drawing title	<p style="text-align: center;">WORKS PLANS</p> <p style="text-align: center;">REGULATION 5(2)(j)</p> <p style="text-align: center;">SHEET 12 - COMPOSITE</p>		
Drawing Number	HE540039-CJV-BOP-SZZ GN000000 -DR-CX-20057		



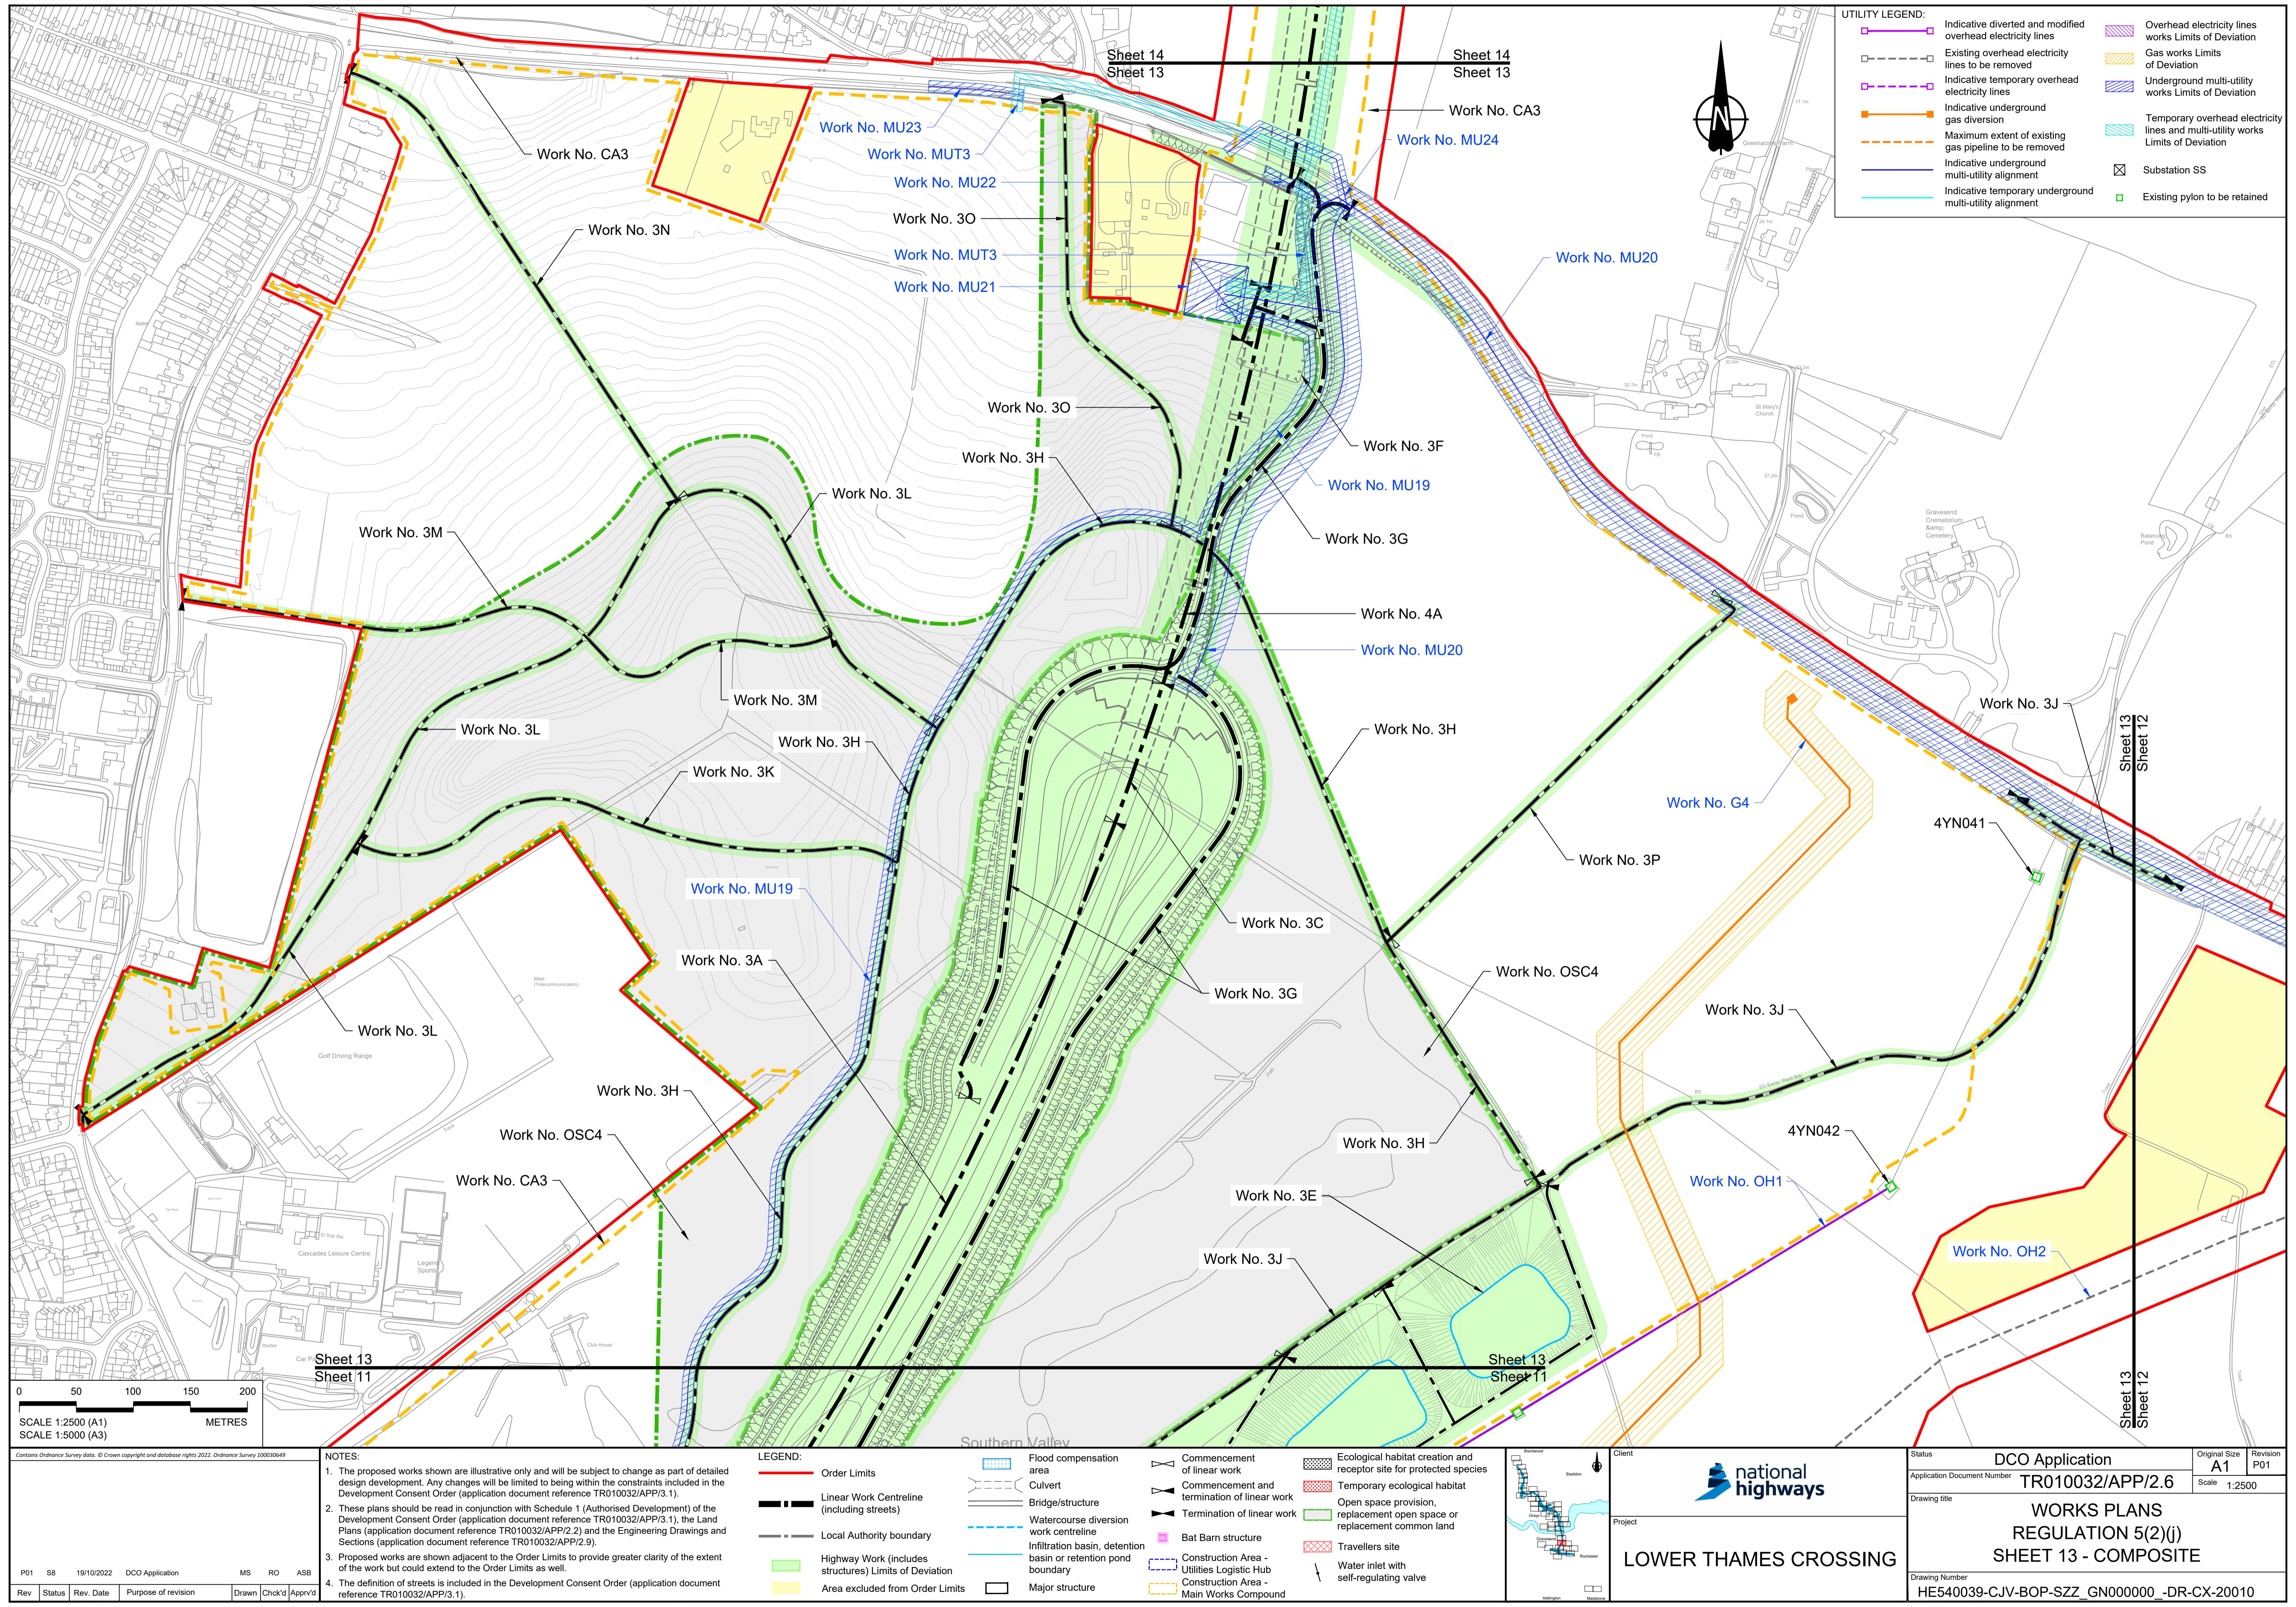
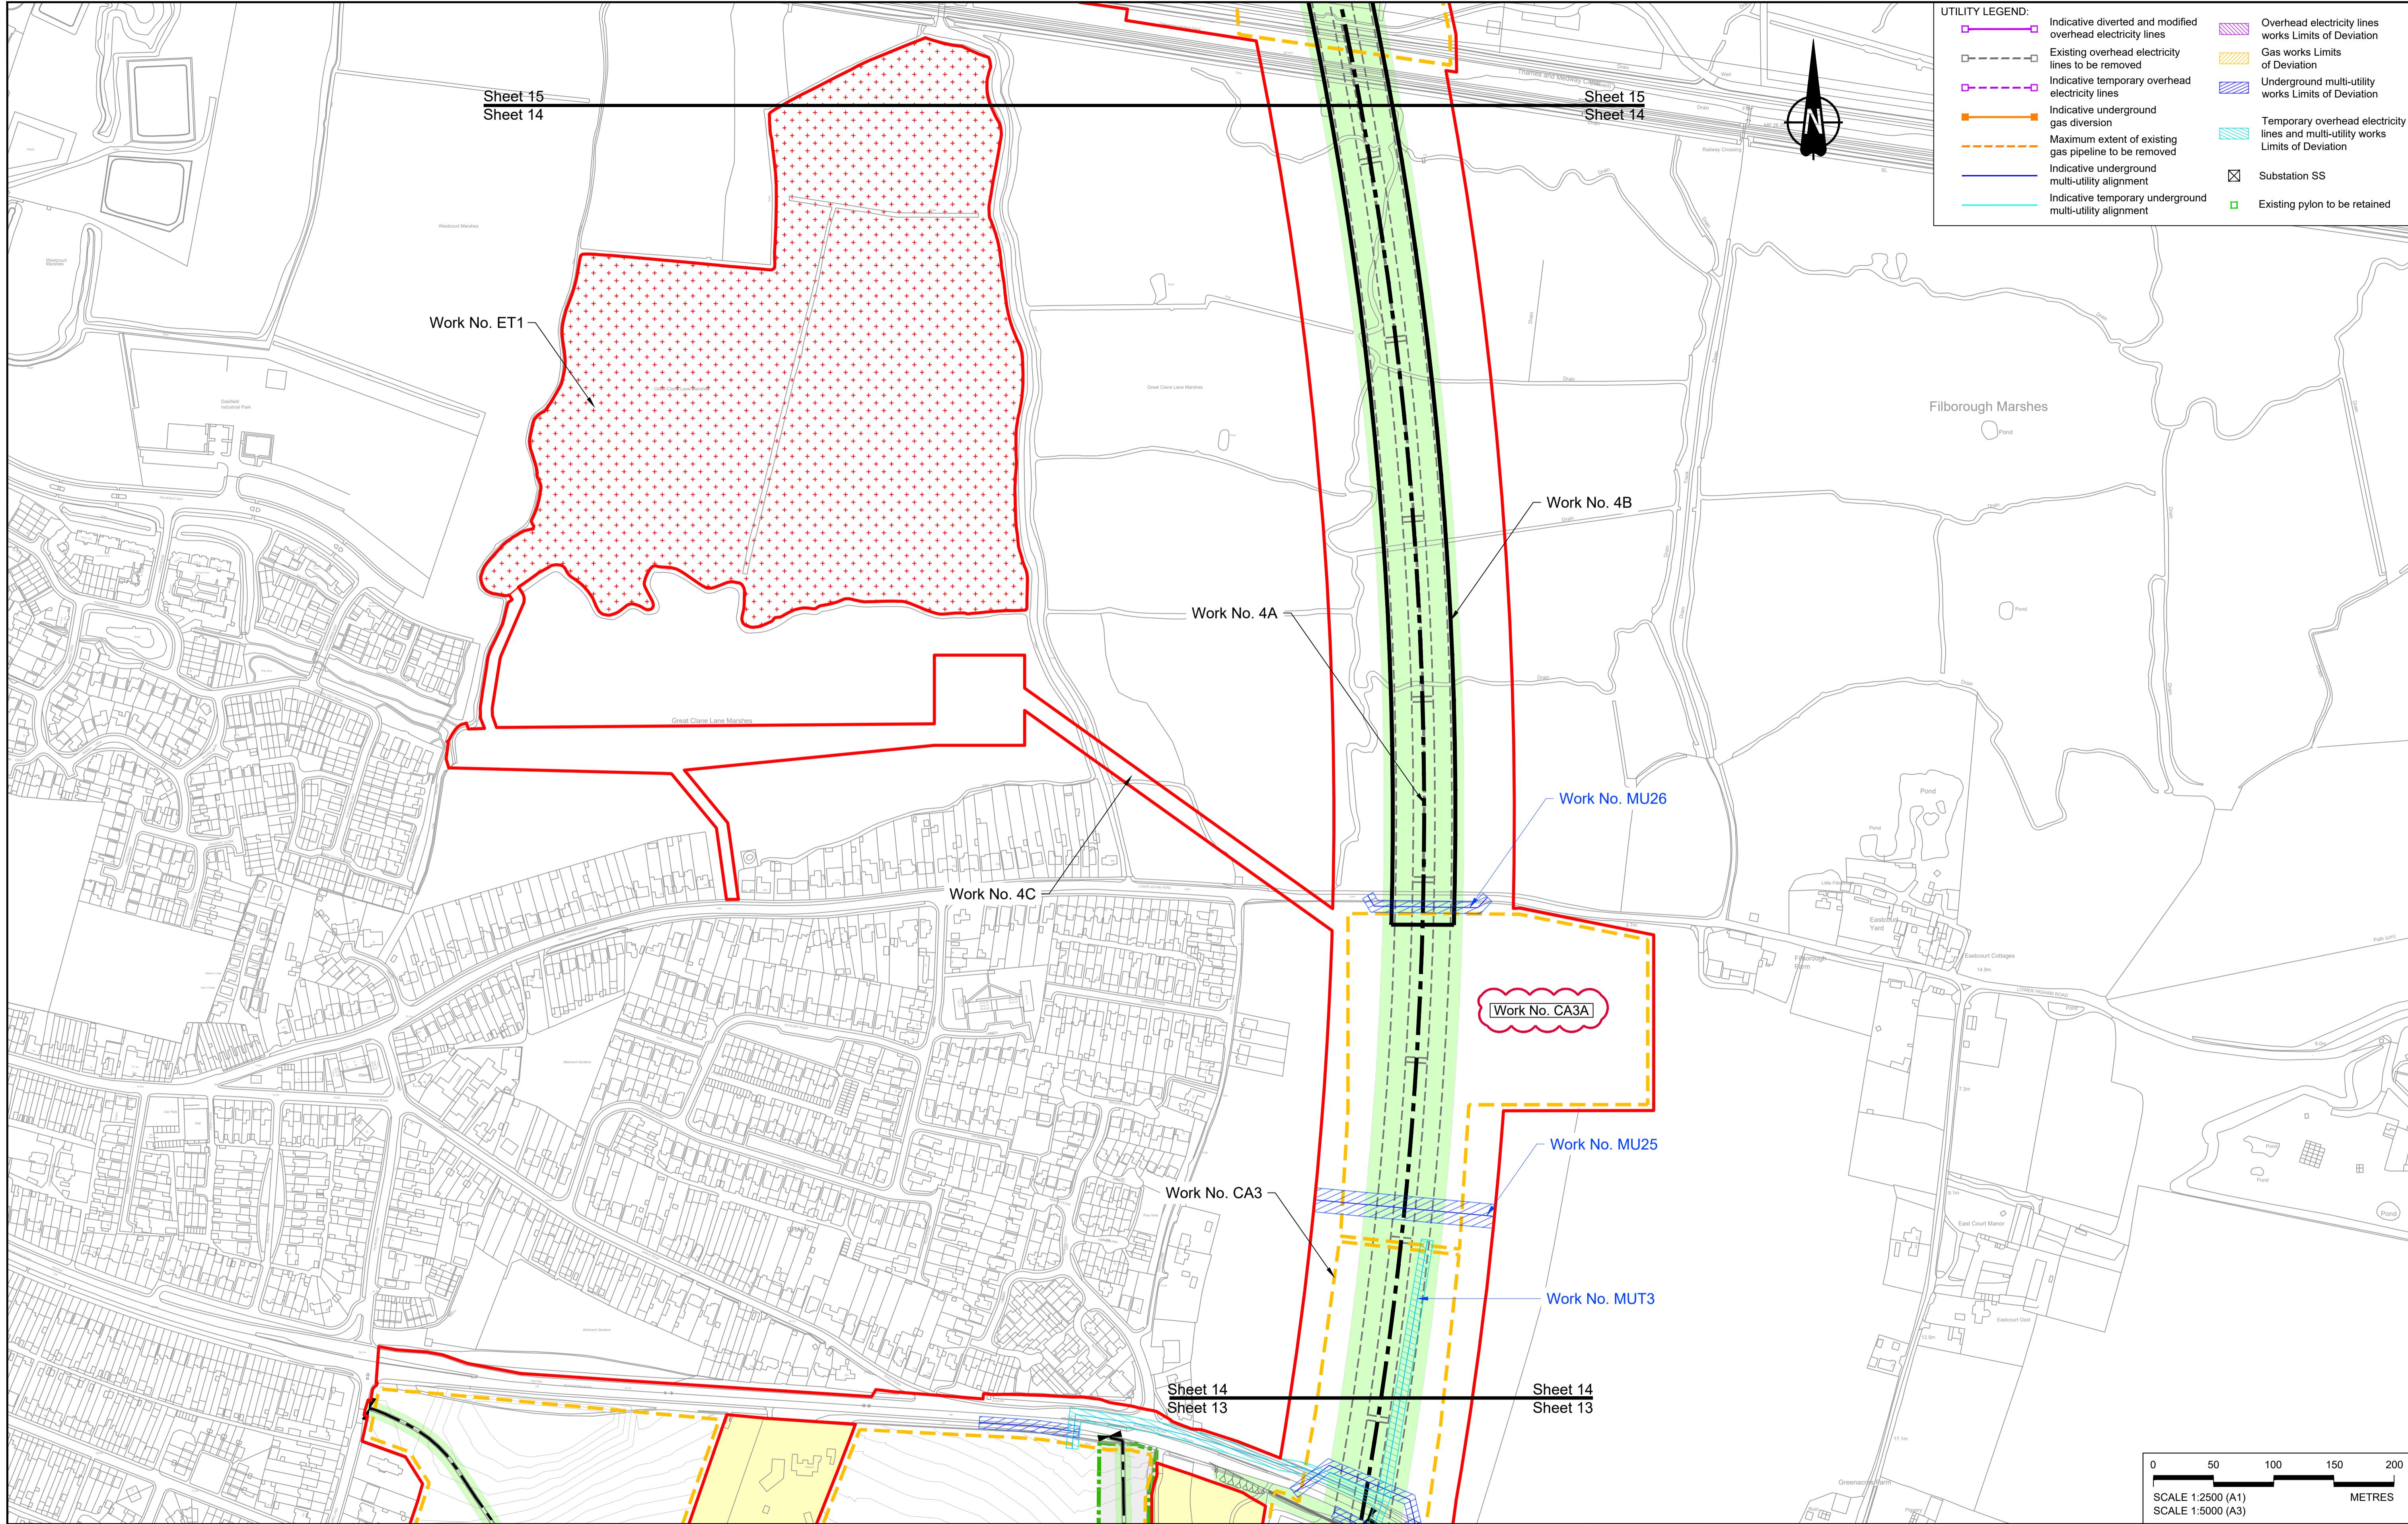
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NOTES:


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LEGEND:

Order Limits	Flood compensation area	Commencement of linear work	Ecological habitat creation and receptor site for protected species
Linear Work Centreline (including streets)	Culvert	Commencement and termination of linear work	Temporary ecological habitat
Local Authority boundary	Bridge/structure	Termination of linear work	Open space provision, replacement open space or replacement common land
Highway Work (includes structures) Limits of Deviation	Watercourse diversion work centreline	Bat Barn structure	Bat Barn structure
Area excluded from Order Limits	Infiltration basin, detention basin or retention pond boundary	Construction Area - Utilities Logistic Hub	Travellers site
	Major structure	Construction Area - Main Works Compound	Water inlet with self-regulating valve

Client: national highways
Project: LOWER THAMES CROSSING
Status: DCO Application A1 Revision P02
Application Document Number: TR010032/APP/2.6 Scale 1:2500
Drawing title: WORKS PLANS REGULATION 5(2)(j)
SHEET 14 - COMPOSITE
Drawing Number: HE540039-CJV-BOP-SZZ_GN000000_DR-CX-20011

P01 S8 19/10/2022 DCO Application MS RO ASB
P02 S8 13/12/2022 Revision following S51 advice MS RO ASB
Rev Status Rev. Date Purpose of revision Drawn Chk'd Apprv'd

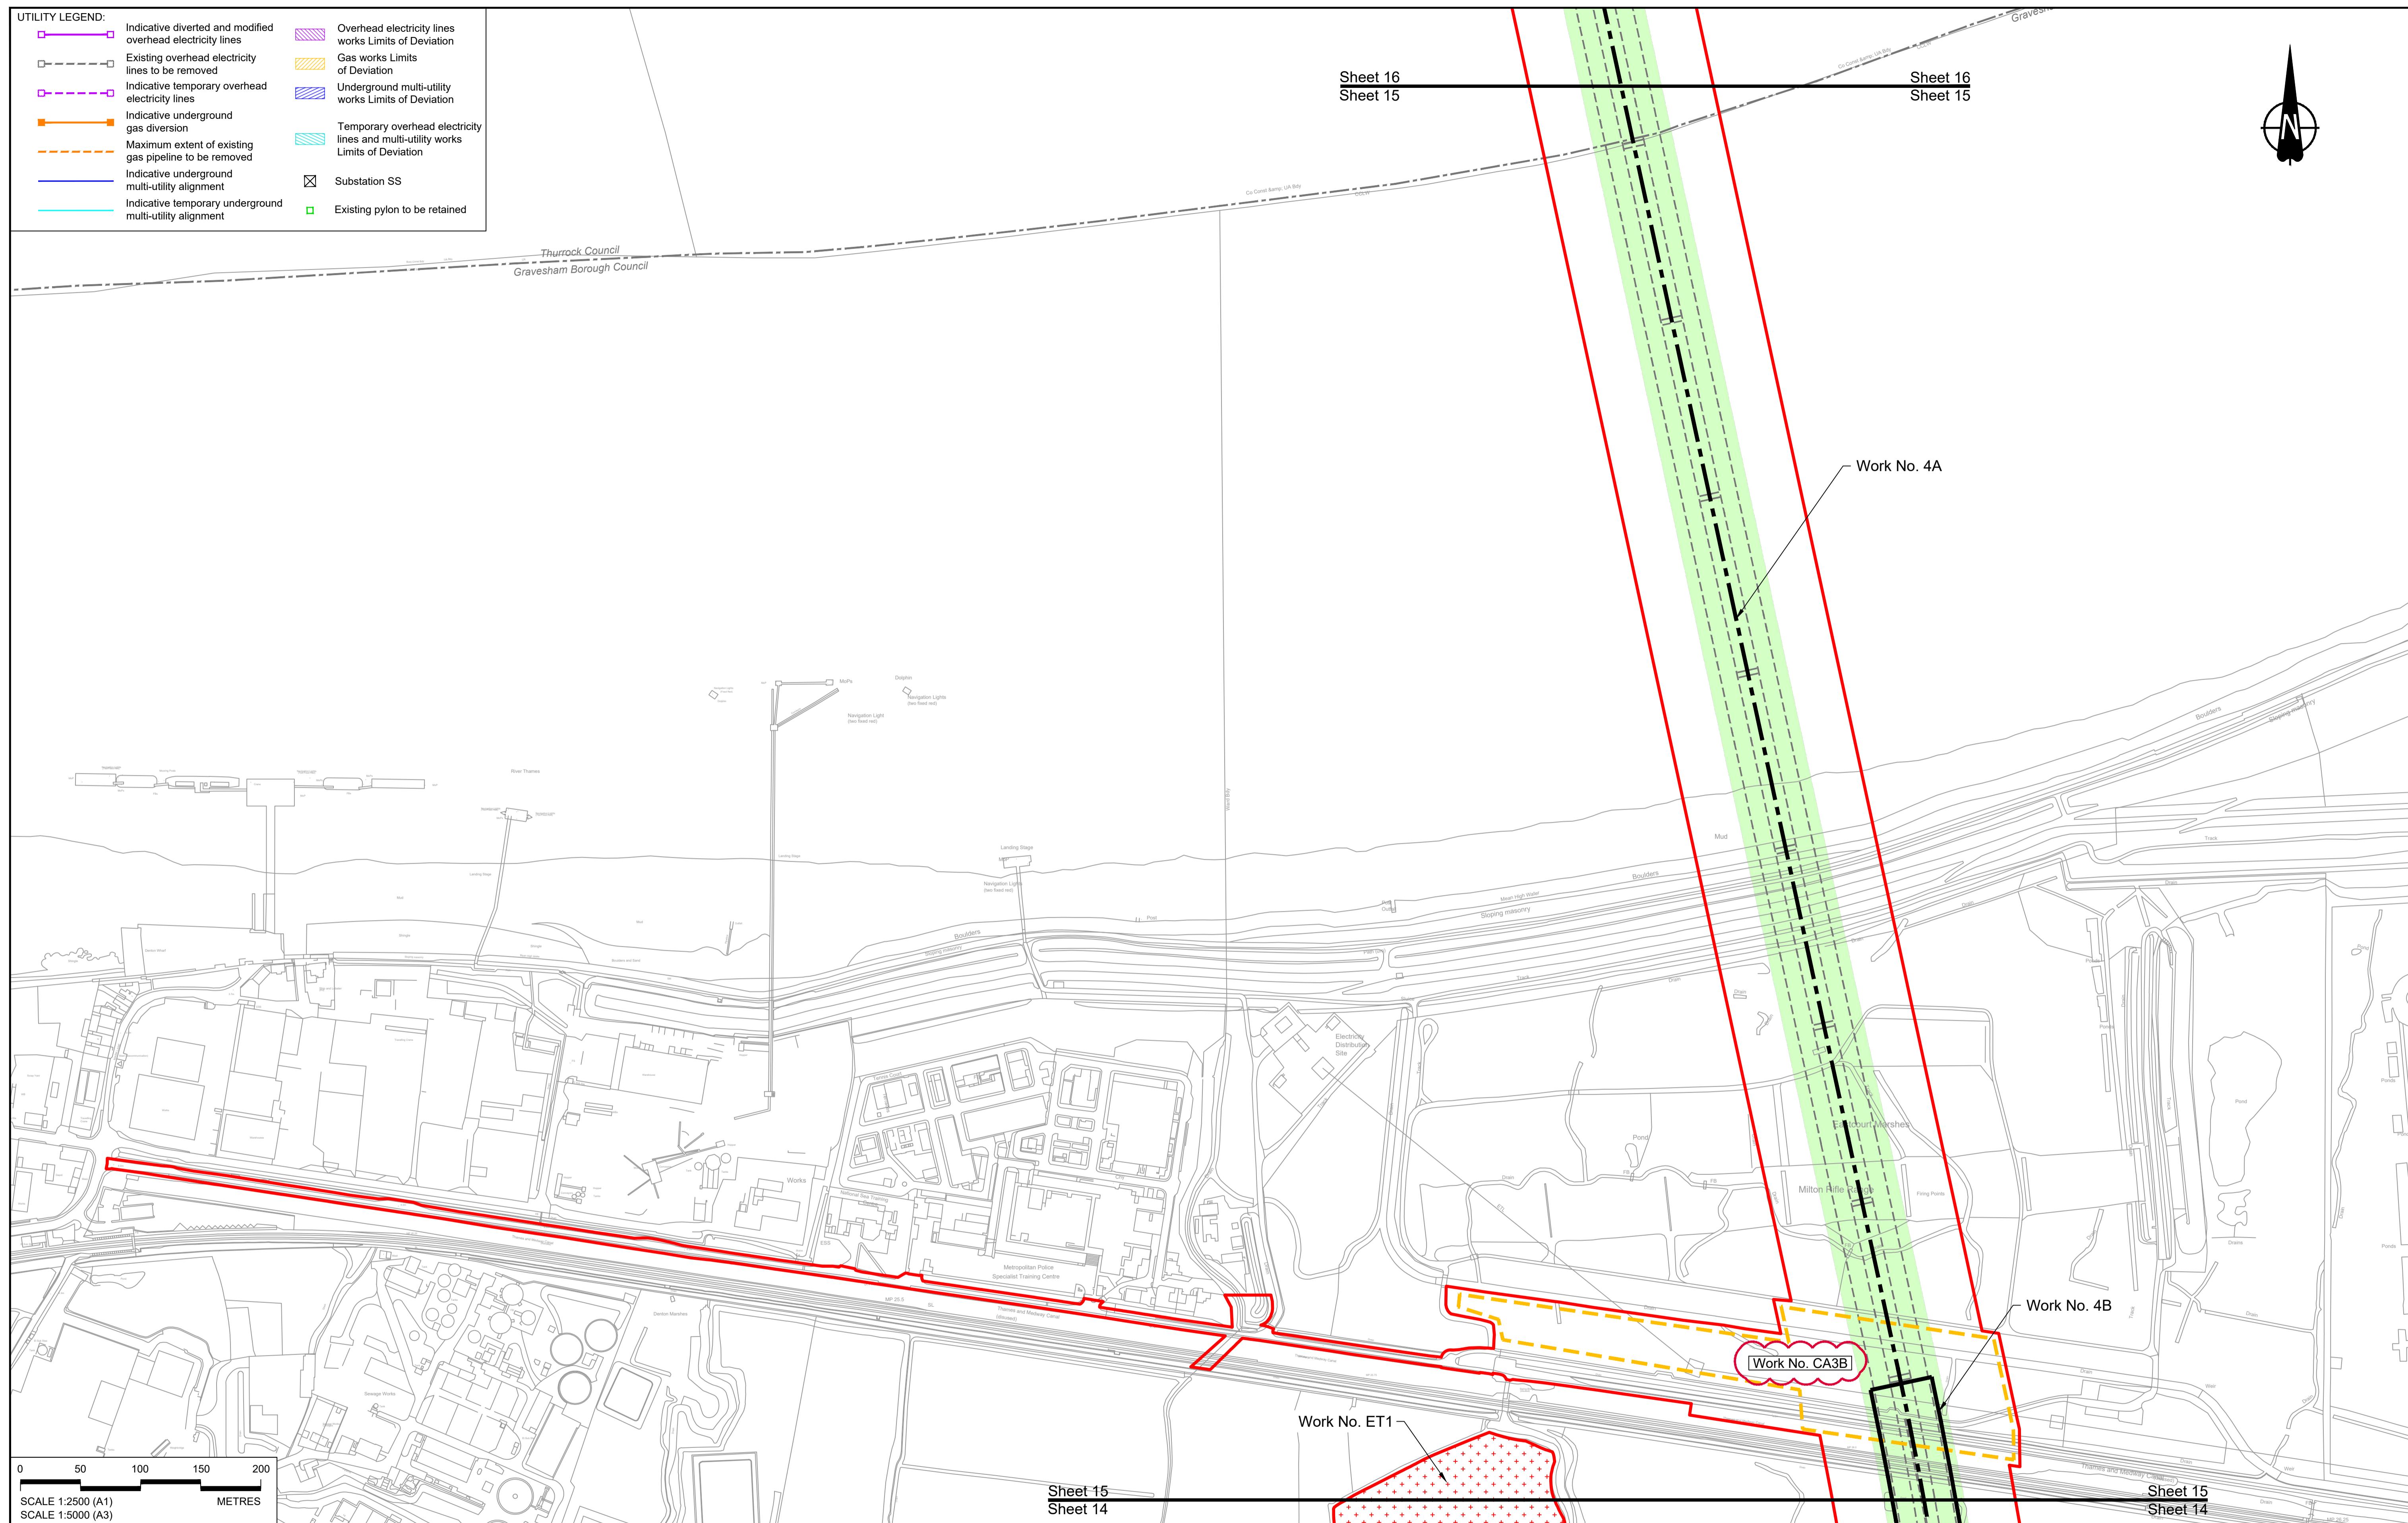

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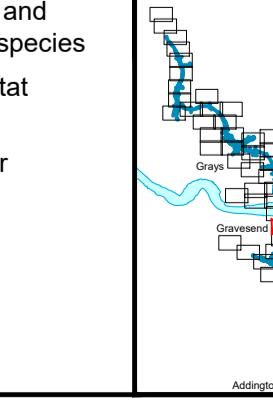
- NOTES:**

 1. The proposed works shown are illustrative only and will be subject to change as part of detailed design development. Any changes will be limited to being within the constraints included in the Development Consent Order (application document reference TR010032/APP/3.1).
 2. These plans should be read in conjunction with Schedule 1 (Authorised Development) of the Development Consent Order (application document reference TR010032/APP/3.1), the Land Plans (application document reference TR010032/APP/2.2) and the Engineering Drawings and Sections (application document reference TR010032/APP/2.9).
 3. Proposed works are shown adjacent to the Order Limits to provide greater clarity of the extent of the work but could extend to the Order Limits as well.
 4. The definition of streets is included in the Development Consent Order (application document reference TR010032/APP/3.1).

LEGEND:


- Order Limits
- Linear Work Centre (including streets)
- Local Authority boundary
- Highway Work (including structures) Limits of D
- Area excluded from C


-



The image shows the National Highways logo at the top right, featuring a stylized blue bridge icon followed by the text "national highways". To the left, there is a map of the Lower Thames Crossing project area. The map includes a compass rose, the town of Basildon at the top left, and the city of Rochester at the bottom left. A red vertical line marks the proposed alignment of the crossing across the River Thames.

Status	DCO Application	Original Size A1	Revision P02
Application Document Number	TR010032/APP/2.6	Scale 1:2500	
Drawing title	<p style="text-align: center;">WORKS PLANS</p> <p style="text-align: center;">REGULATION 5(2)(j)</p> <p style="text-align: center;">SHEET 15 - COMPOSITE</p>		
Drawing Number	HE540039-CJV-BOP-SZZ_GN000000_DR-CX-20012		

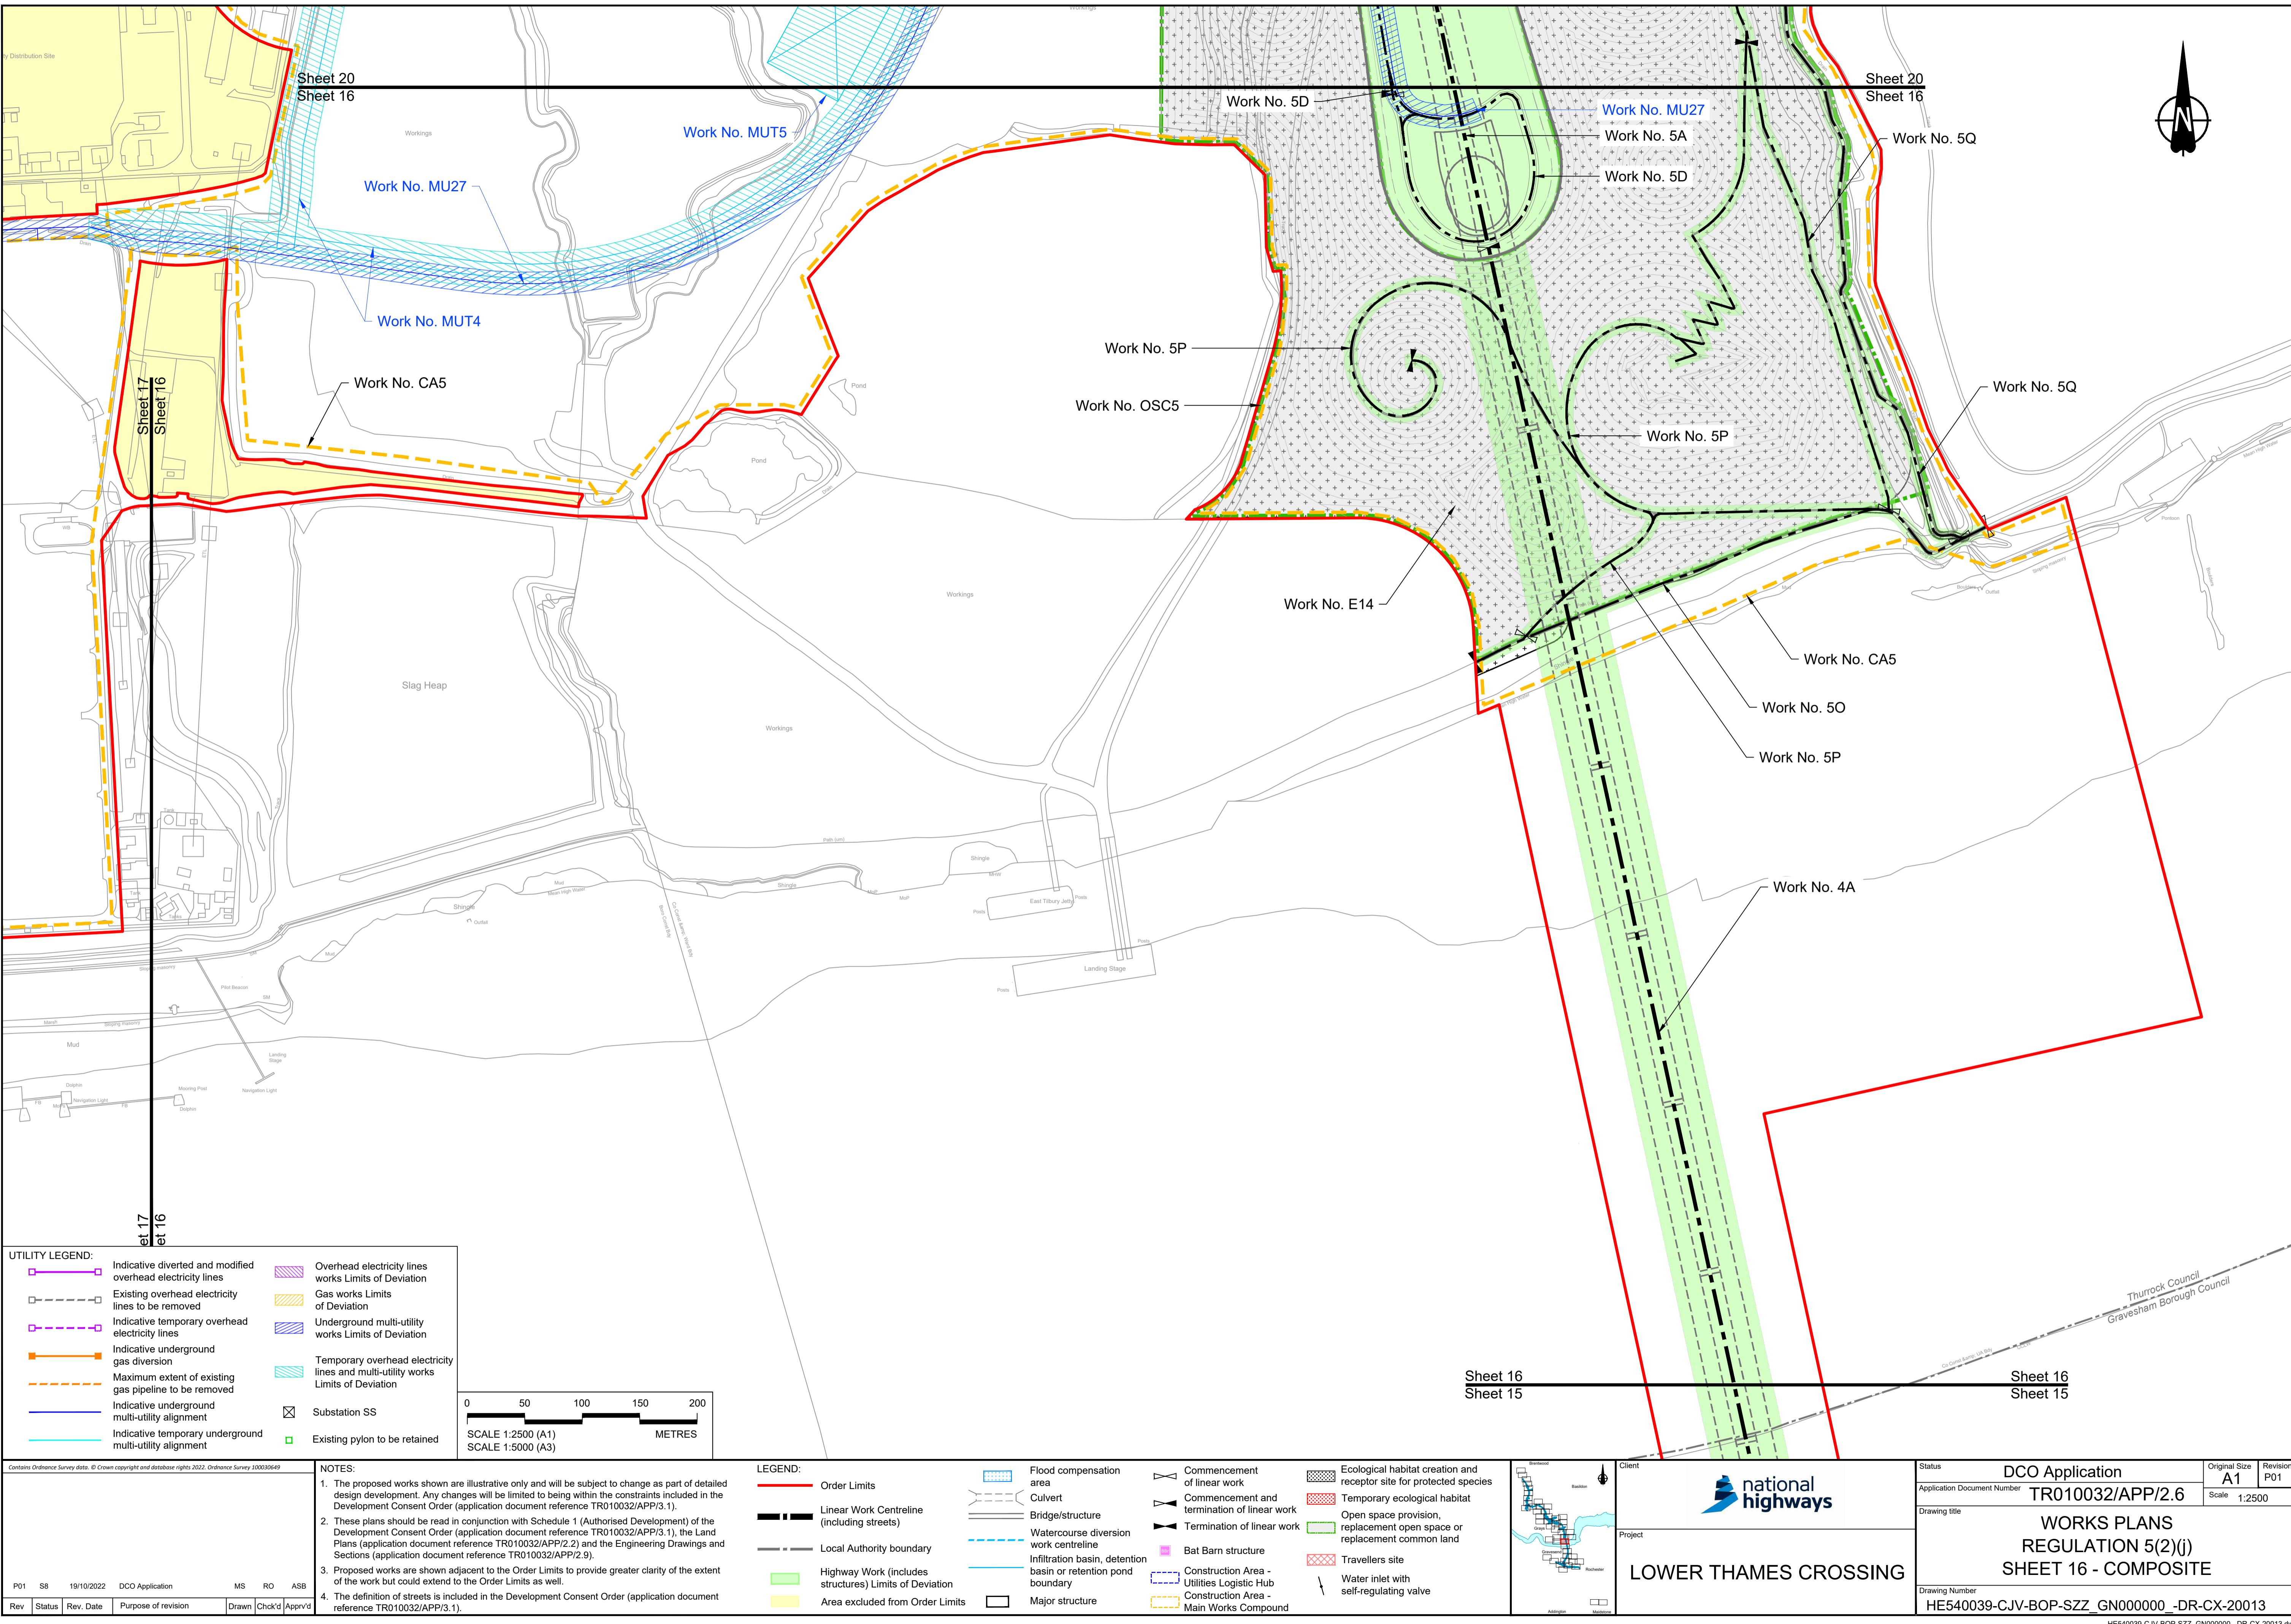

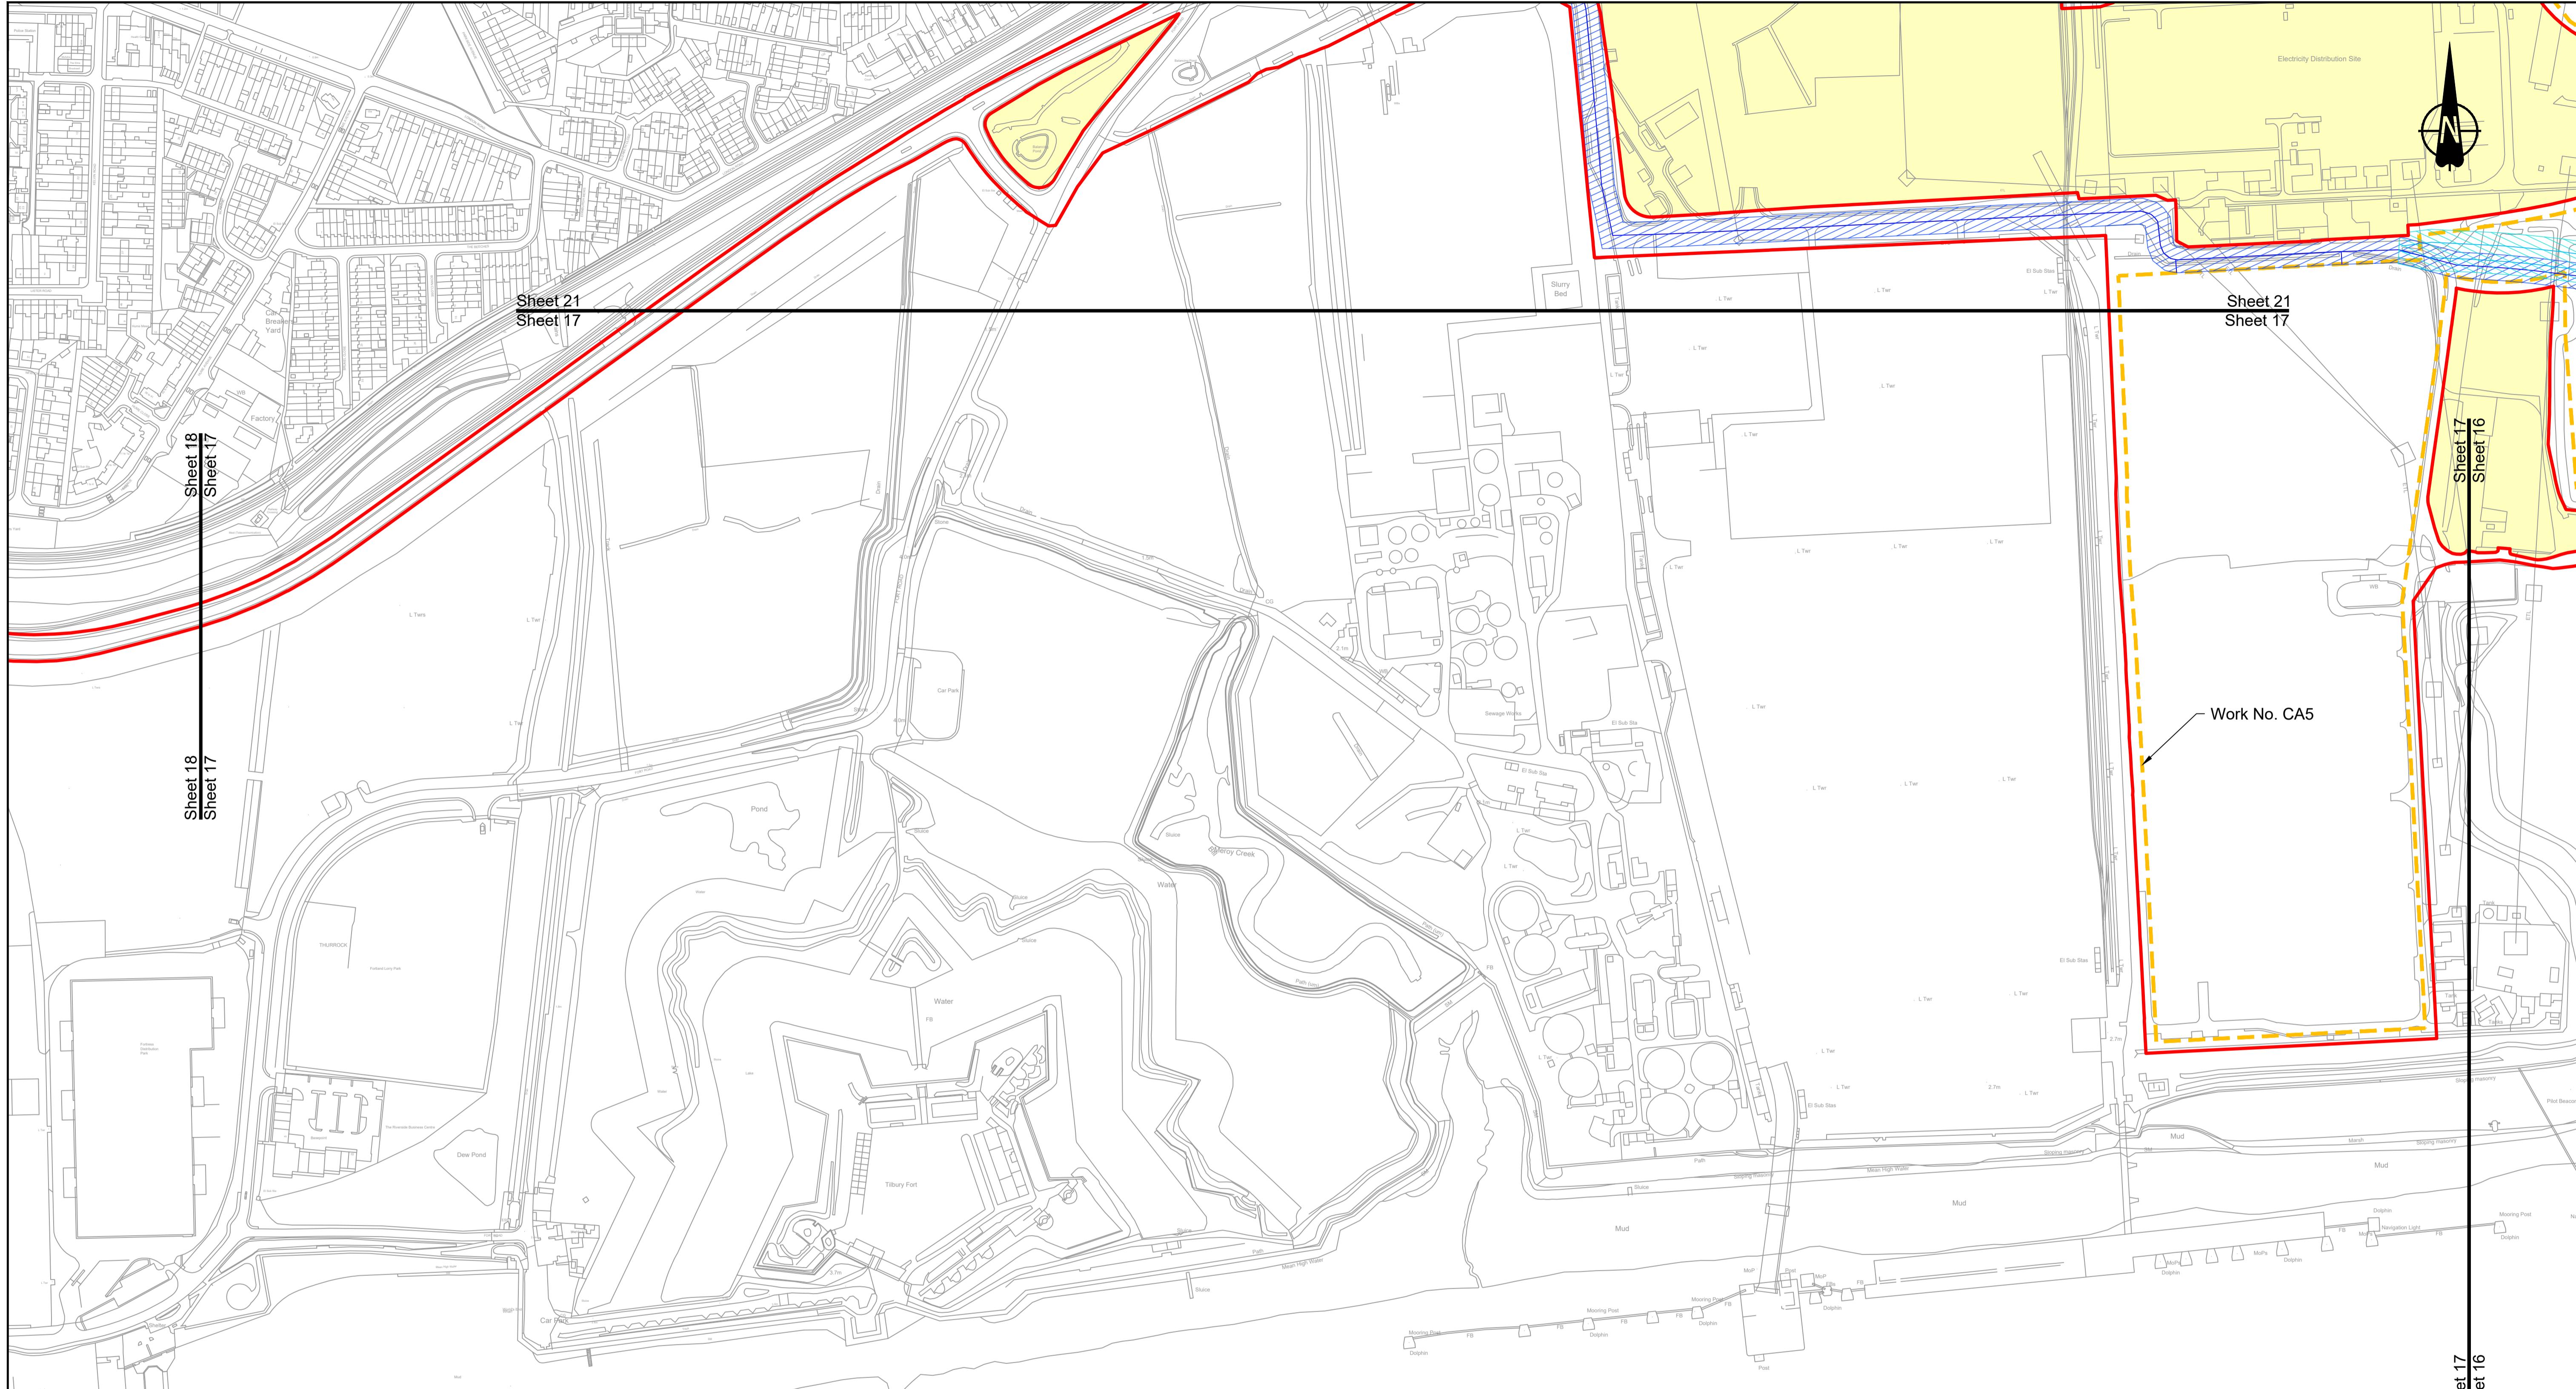


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NOTES:											
1. The proposed works shown are illustrative only and will be subject to change as part of detailed design development. Any changes will be limited to being within the constraints included in the Development Consent Order (application document reference TR010032/APP/3.1).											
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4. The definition of streets is included in the Development Consent Order (application document reference TR010032/APP/3.1).											

P01	S8	19/10/2022	DCO Application	MS	RO	ASB
Rev	Status	Rev. Date	Purpose of revision	Drawn	Chk'd	Apprv'd

LEGEND:
— Order Limits
— Linear Work Centreline (including streets)
— Local Authority boundary
— Highway Work (includes structures) Limits of Deviation
— Flood compensation area
— Culvert
— Bridge/structure
— Watercourse diversion work centreline
— Infiltration basin, detention basin or retention pond boundary
— Major structure
— Commencement of linear work
— Commencement and termination of linear work
— Termination of linear work
— Ecological habitat creation and receptor site for protected species
— Temporary ecological habitat
— Open space provision, replacement open space or replacement common land
— Travellers site
— Construction Area - Utilities Logistic Hub
— Construction Area - Main Works Compound
— Bat Barn structure
— Construction Area - Main Works Compound
— Water inlet with self-regulating valve
— Area excluded from Order Limits

Client		Status	DCO Application	Original Size
		Application Document Number	TR010032/APP/2.6	Revision P01
Drawing title	WORKS PLANS	Scale	1:2500	
	REGULATION 5(2)(j)			
Project	SHEET 17 - COMPOSITE			
Drawing Number	HE540039-CJV-BOP-SZZ_GN000000_DR-CX-20014			

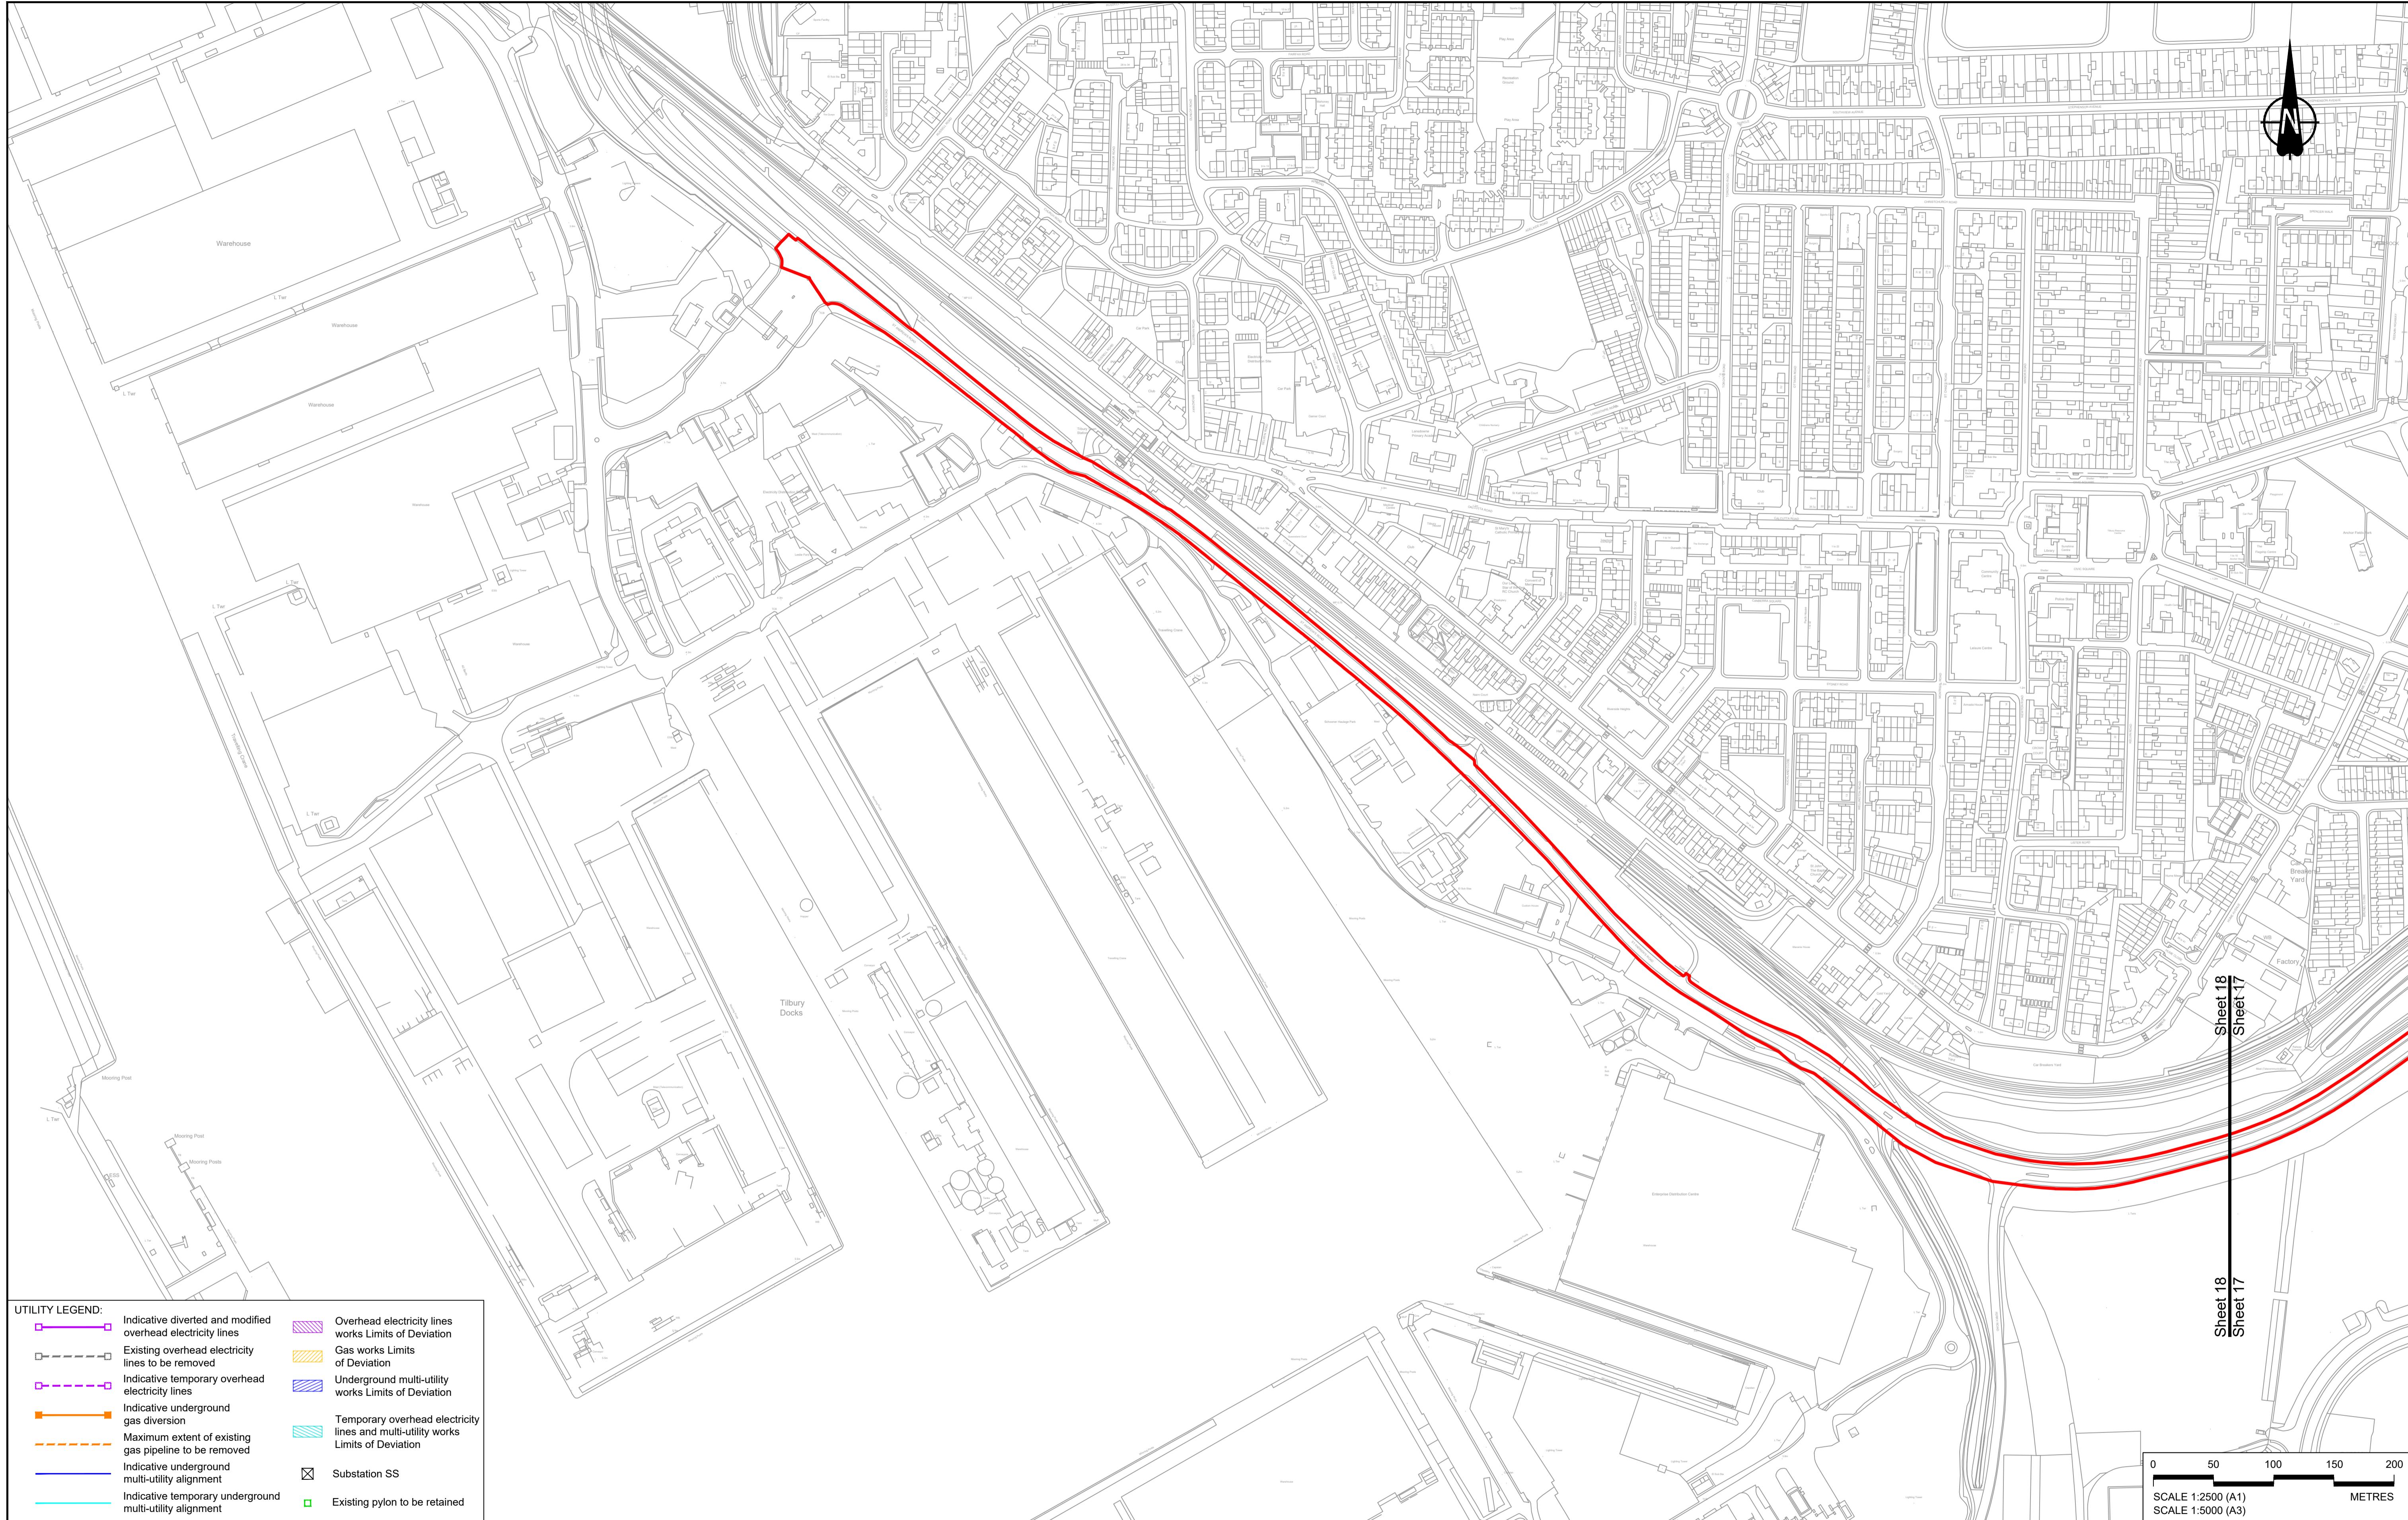

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P01 S8 19/10/2022 DCO Application MS RO ASB

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LEGEND:


- Order Limits
- Linear Work Centreline (including streets)
- Local Authority boundary
- Highway Work (includes structures) Limits of Deviation
- Area excluded from Order Limits
- Flood compensation area
- Culvert
- Bridge/structure
- Watercourse diversion work centreline
- Infiltration basin, detention basin or retention pond boundary
- Major structure
- Commencement of linear work
- Commencement and termination of linear work
- Termination of linear work
- Bat Barn structure
- Construction Area - Utilities Logistic Hub
- Construction Area - Main Works Compound
- Ecological habitat creation and receptor site for protected species
- Temporary ecological habitat
- Open space provision, replacement open space or replacement common land
- Travellers site
- Water inlet with self-regulating valve


Client

Project

LOWER THAMES CROSSING

Status	DCO Application	Original Size	Revision
Application Document Number	TR010032/APP/2.6	P01	P01
Scale	1:2500		
Drawing title	WORKS PLANS		
	REGULATION 5(2)(j)		
	SHEET 18 - COMPOSITE		
Drawing Number	HE540039-CJV-BOP-SZZ_GN000000_DR-CX-20015		

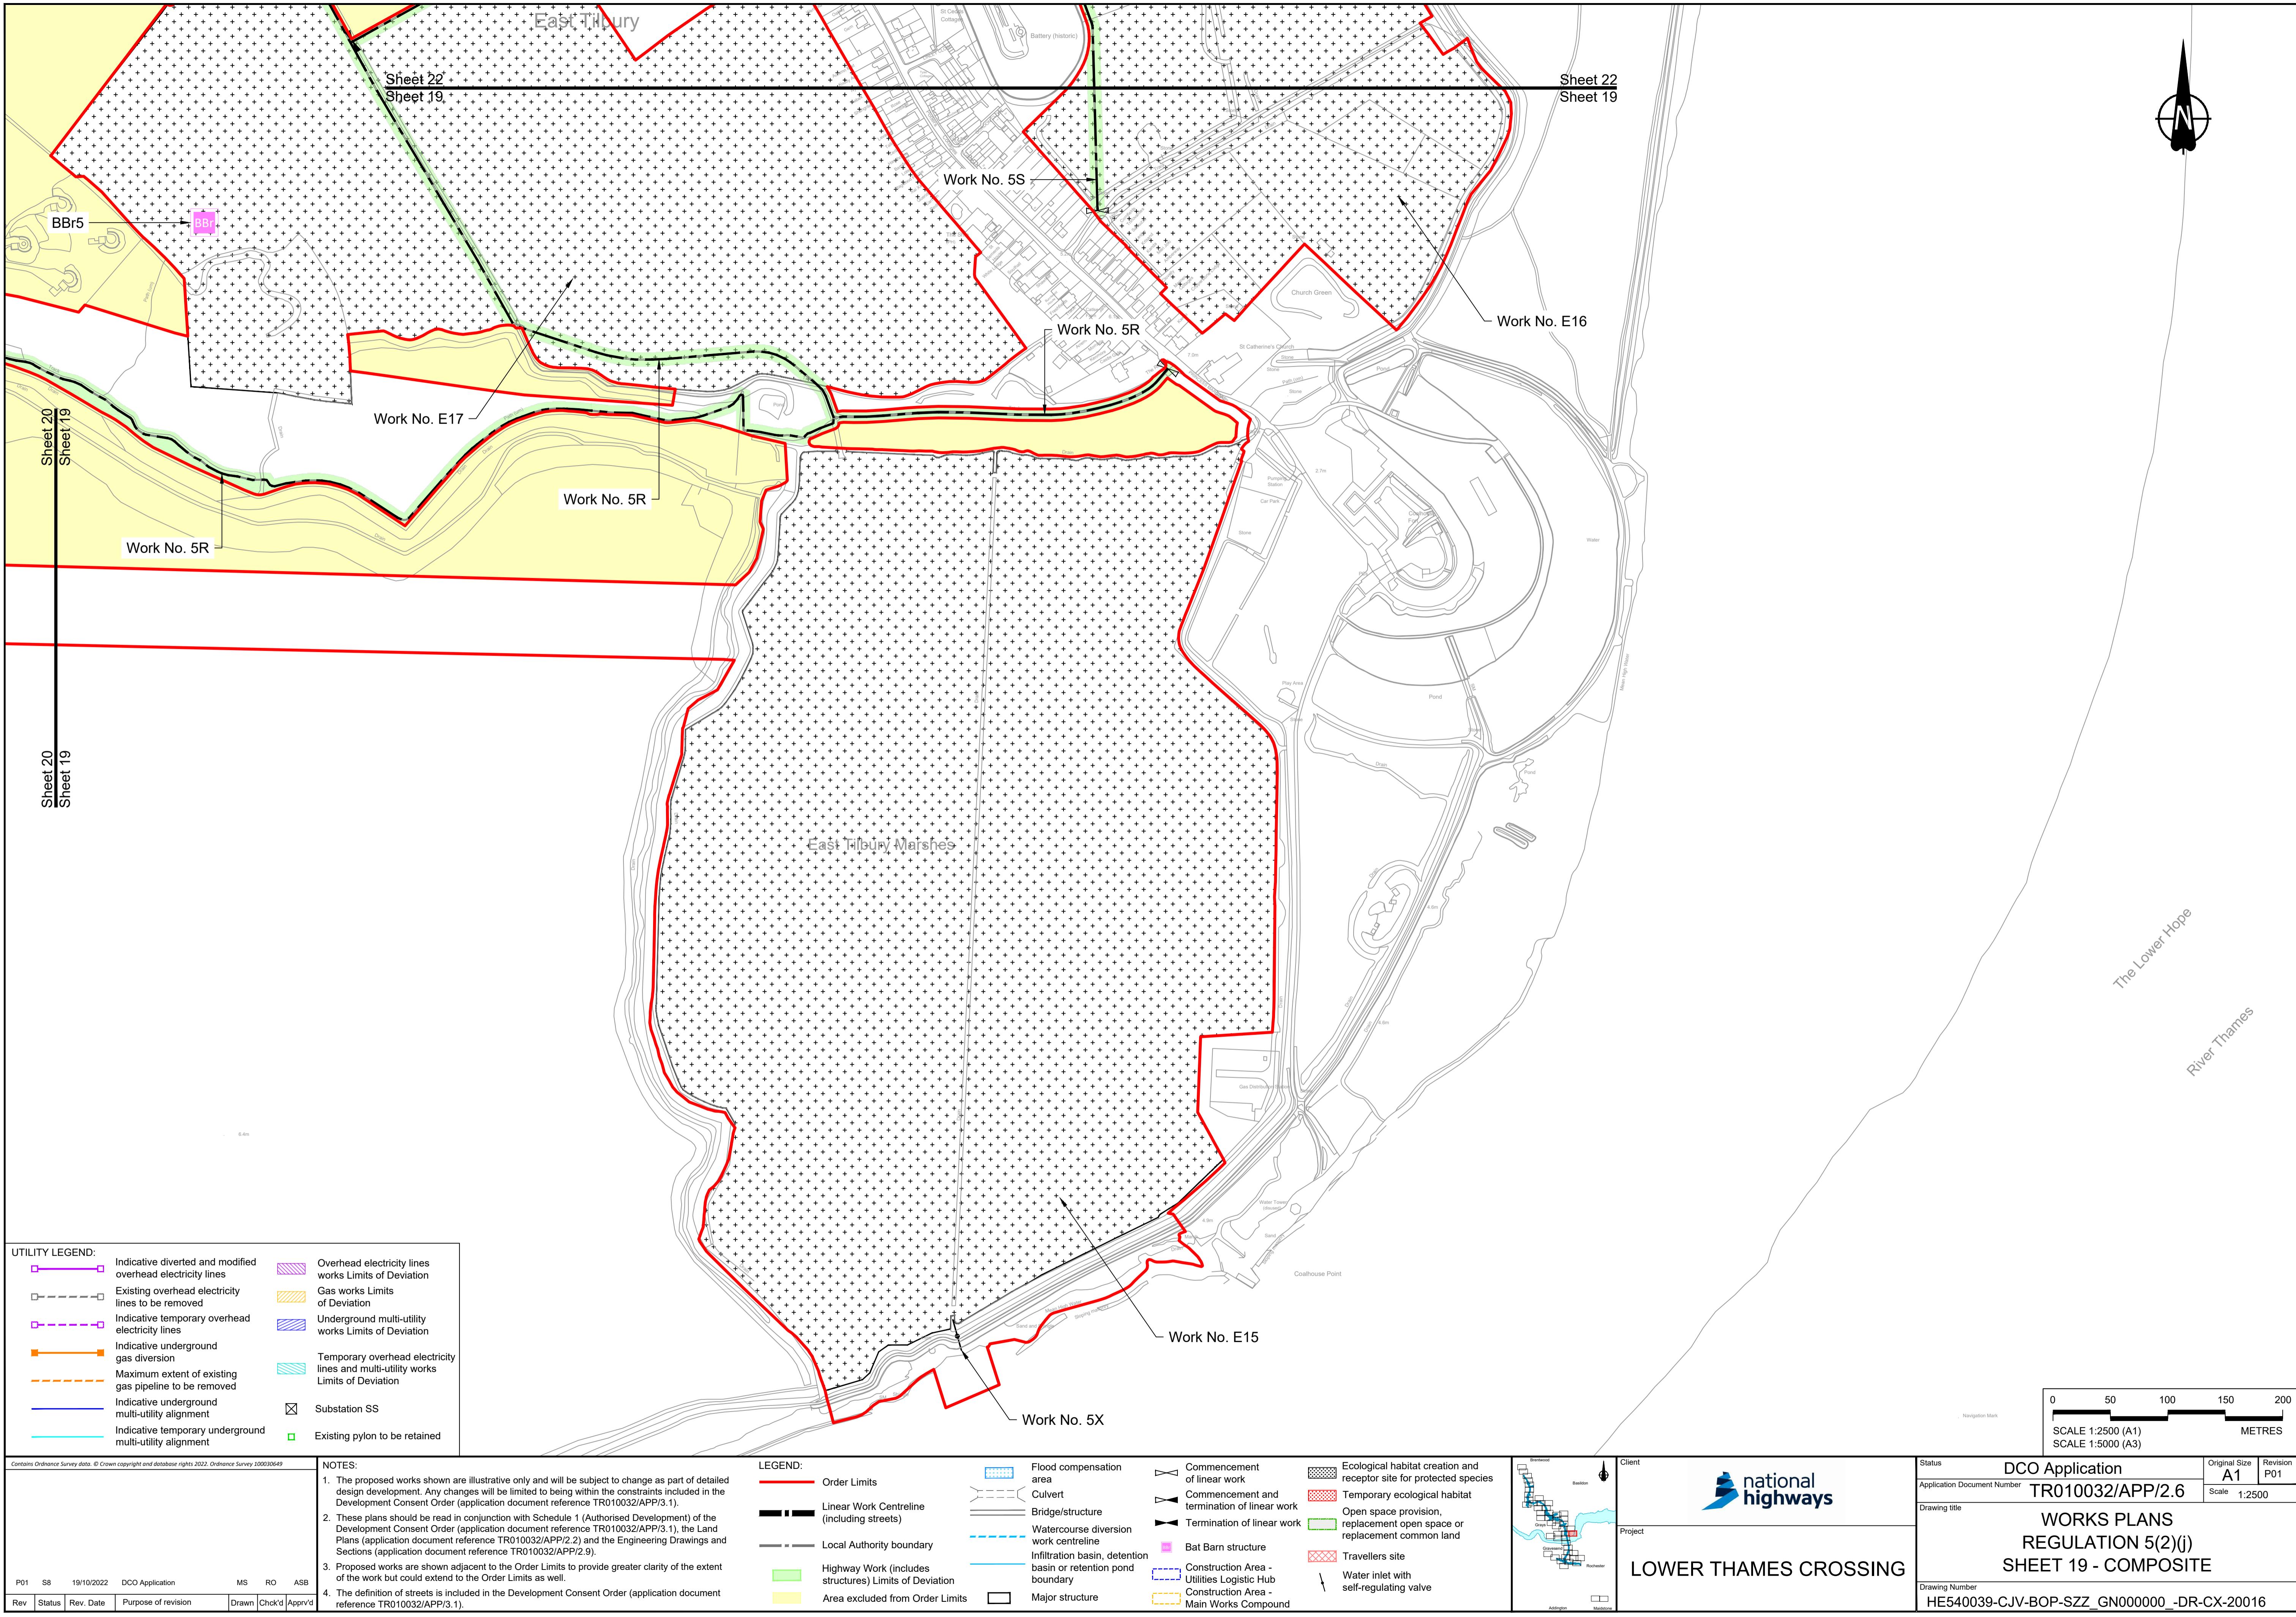

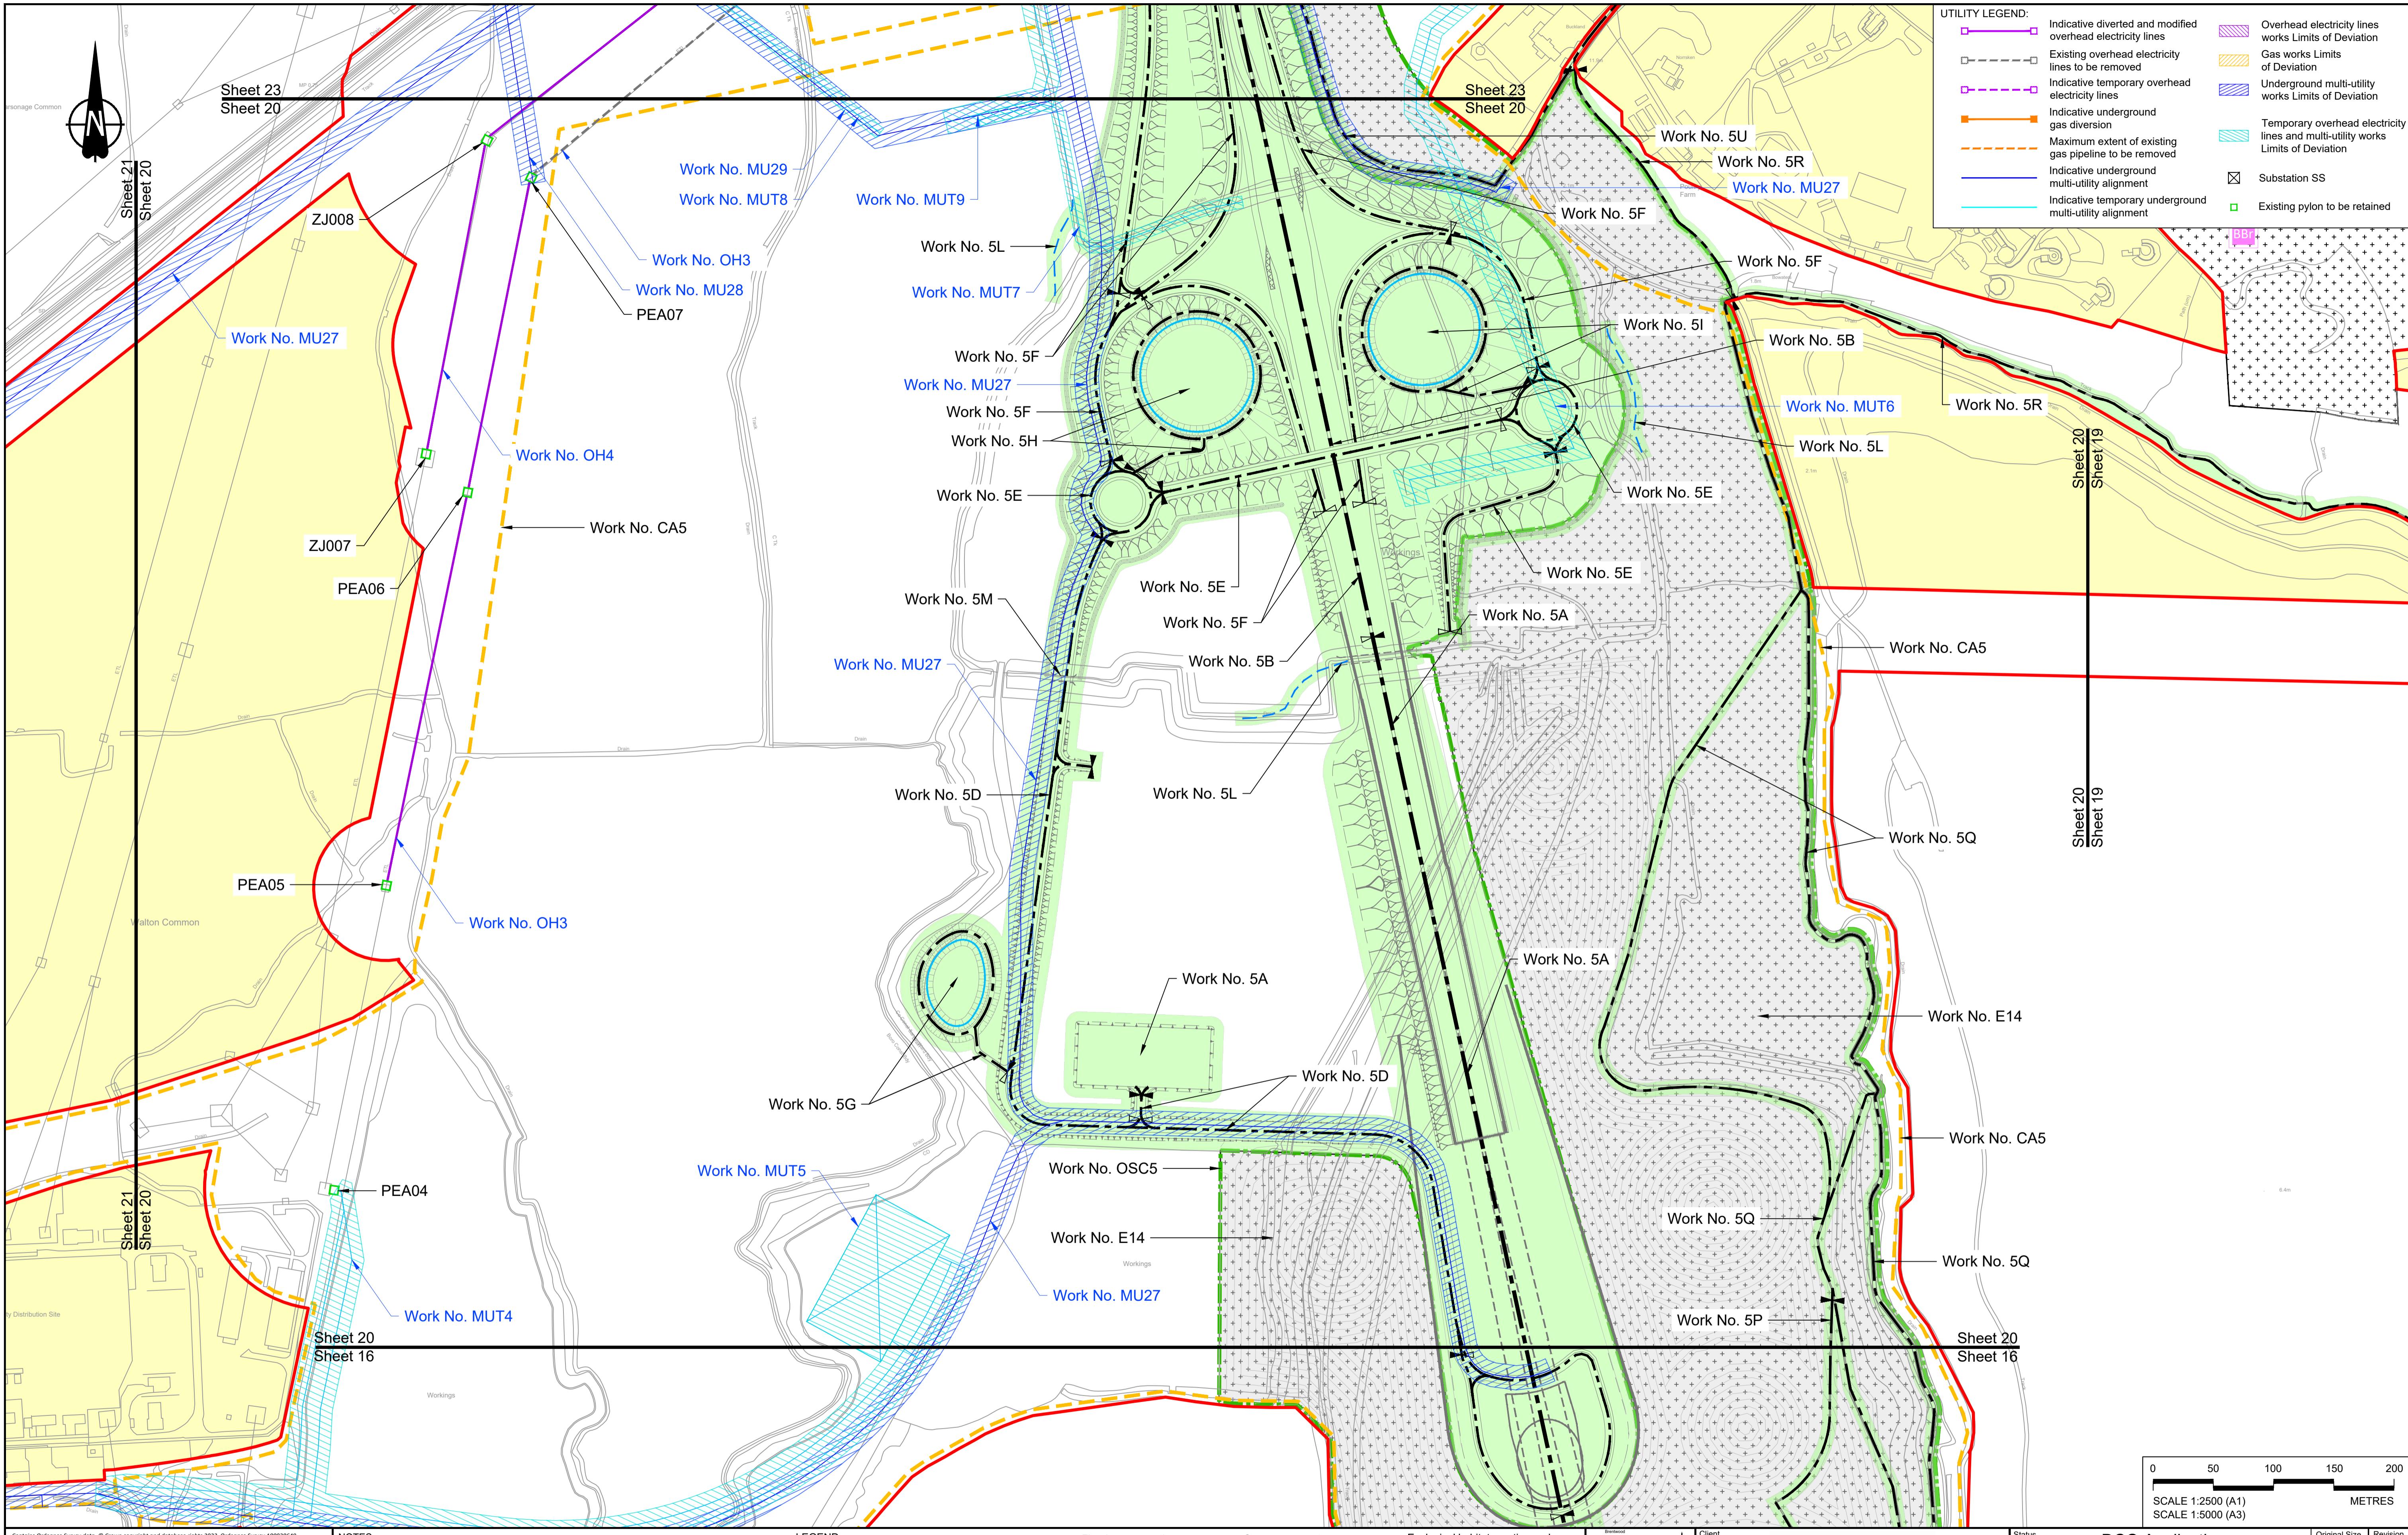

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P01 S8 19/10/2022 DCO Application MS RO ASB
Rev Status Rev. Date Purpose of revision Drawn Chkd Apprv'd

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LEGEND:
Order Limits
Linear Work Centreline (including streets)
Local Authority boundary
Highway Work (includes structures) Limits of Deviation
Flood compensation area
Culvert
Bridge/structure
Watercourse diversion work centreline
Infiltration basin, detention basin or retention pond boundary
Major structure
Commencement of linear work
Commencement and termination of linear work
Termination of linear work
Ecological habitat creation and receptor site for protected species
Temporary ecological habitat
Open space provision, replacement open space or replacement common land
Bat Barn structure
Travellers site
Construction Area - Utilities Logistic Hub
Construction Area - Main Works Compound

Area excluded from Order Limits

Client
national highways
Project
LOWER THAMES CROSSING

Status A1 Revision P01
Application Document Number TR010032/APP/2.6 Scale 1:2500
Drawing title WORKS PLANS
Project REGULATION 5(2)(j)
Drawing Number HE540039-CJV-BOP-SZZ_GN000000_DR-CX-20017
Drawing Number HE540039-CJV-BOP-SZZ_GN000000_DR-CX-20017.dwg

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